
OLD TOWN BOUTIQUE HOTEL

OLD TOWN FRONT STREET RIVERSIDE COUNTY. TEMECULA, CA.

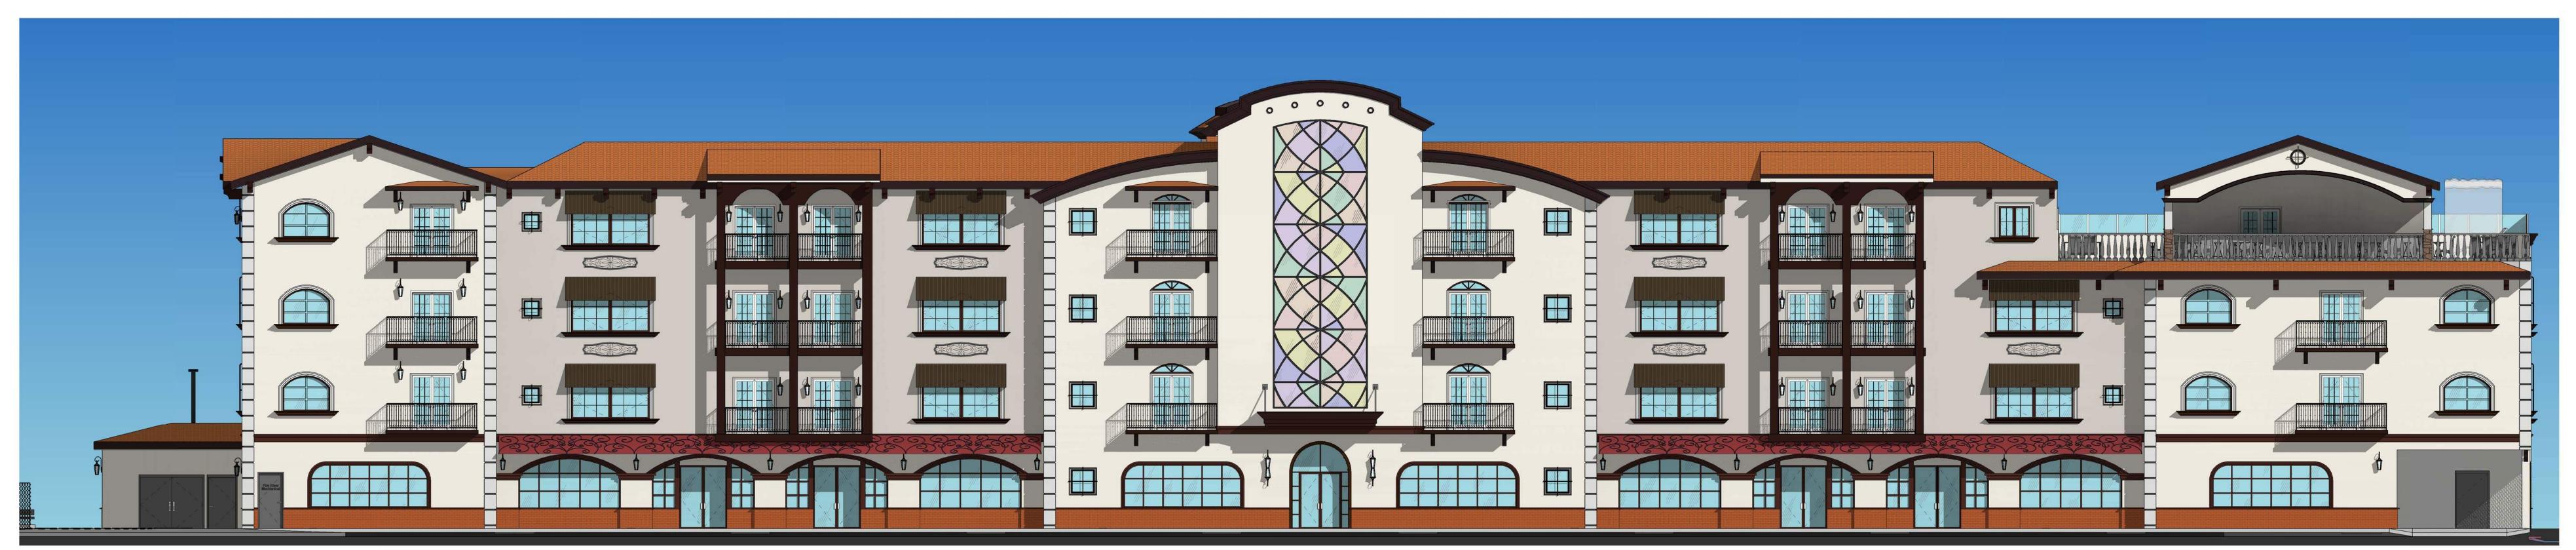

DEVELOPMENT PLAN SUBMITTAL #5
PA22 - 0929
PA22 - 0930
PA22 - 0931

LEGAL DESCRIPTION	PROJECT INFORMA	ATION 5/15/202	UTILITY PROVIDERS	APPLICANT'S REPRESENTATIVE/ARCHITECT	VICINITY MAP
THE PROPOSED PROJECT IS A SELECT SERVICE HOTEL. THE FACILITY IS A 24/7 OPERATION. REQUIRED PARKING STALLS IS 50 STALLS. AVERAGE DAILY TRIPS IS EQUAL TO THE NUMBER OF PARKING. AS THIS IS A	TOTAL GROSS SITE AREA:	.98 AC 42,519 SF	WATER - RCWD	COMPANY NAME: WALTER R. ALLEN ARCHITECT + ASSOCIATES ADDRESS: 28465 OLD TOWN FRONT STREET #201 TEMECULA CA. 92590	
HOTEL. NO HAZARDOUS MATERIALS/CHEMICAL PROCESSING/ OR SIGNIFICANT EQUIPMENT IS PROPOSED. THERE WILL BE A KITCHEN/BAR/ AND POOL AREA AS AMENITIES FOR THE GUESTS AND FOR VISITORS.	NET COVERAGE:	,	SEWER - EMWD	PHONE: 951-693-0301	
	FLOOR AREA RATIO	60,258 (GROSS BLD SF) / 42,519 (LOT SF) = 1.41 FAR	ELECTRIC - SO CAL EDISON		→
	TOTAL BUILDING AREA:	60,258 SF	SHEET INDEX	LANDSCAPE ARCHITECT	
STATEMENT OF OPERATIONS	151: 2ND: 3RD: 4TH:	11,633 SF 17,535 SF 17,384 SF 13,705 SF	T100 TITLE SHEET A1.0 PROPOSED SITE PLAN A1.1 SITE DETAILS	COMPANY NAME: ALHAMBRA GROUP ADDRESS: 41635 ENTERPRISE CIRCLE NORTH, SUITE C, TEMECULA CA 92590 PHONE: (951) - 296 - 6802	1ST ST CANNINGO RO
THE PROPOSED PROJECT IS A SELECT SERVICE HOTEL. THIS PROJECT WILL CONSISTS OF 50 LUXURY ROOMS, THERE WILL BE 4 TO 6 COMMERCIAL UNITS. THE FACILITY IS A 24/7 OPERATION . REQUIRED PARKING STALLS ARE 50	LANDSCAPE PROVIDED:	11% OF TOTAL SITE 4,684 SF	A1.2 ACCESSIBLE EGRESS PLAN A2.0 FIRST LEVEL FLOOR PLAN A2.1 SECOND LEVEL FLOOR PLAN	ASSESSOR'S PARCEL NO.	WIN FROOM
WITH 24/7 VALET PARKING. AVERAGE DAILY TRIPS IS EQUAL TO THE NUMBER OF PARKING. AS THIS IS A HOTEL NO HAZARDOUS MATERIALS/CHEMICAL PROCESSING/ OR SIGNIFICANT EQUIPMENT IS PROPOSED. THERE WILL BE A KITCHEN/BAR, GYM, AND POOL AREA AS AMENITIES FOR THE GUESTS AND FOR VISITORS. ALCOHOL	50 HOTEL ROOM @ 1/ROOM	50 STALLS	A2.2 THIRD LEVEL FLOOR PLAN A2.3 FOURTH LEVEL FLOOR PLAN A4.0 ROOF PLAN	APN: 922-100-048 M.B. 15/726 LOT# 2 BLOCK 32	STATE
WILL BE SERVED AT THE PROJECT SITE. PROJECT INFORMATION	TOTAL REQUIRED PARKING PROVIDED	50 STALLS STANDARD 47 STALLS	A8.0 BUILDING ELEVATIONS A8.1 BUILDING ELEVATIONS A8.2 DOWNTOWN ARCHITECTURAL STYLE	SCOPE OF WORK	T-WAY.
BUILDING TYPE: 4 STORY, TYPE III-B CONSTRUCTION OCCUPANCY: A2 / A3 / B / R1 SPRINKLER: YES BUILDING HEIGHT: 57' ZONING DESIGNATION: OLD TOWN SPECIFIC PLAN (SP-5) GENERAL PLAN DESIGNATION: SPECIFIC PLAN IMPLEMENTATION - SPI EXISTING LAND USE: VACANT; PROPOSED LAND USE: 4 STORY HOTEL	BICYCLE RACK PROVIDED:	ADA 3 STALLS TOTAL 50 STALLS	A9.0 3D VIEWS A9.1 ISOMETRIC VIEW #1 A9.2 ISOMETRIC VIEW #2 C-1 GRADING PLAN E1.0 LIGHT FIXTURE LOCATION E1.1 PHOTOMETRIC PLAN E1.2 SPECIFICATION SHEET L-1 PRELIMINARY PLANTING PLAN	CONSTRUCTION OF A NEW 4-STORY LUXURY HOTEL PROJECT WITH GROUND LEVEL PARKING. CONSISTS OF GUESTROOMS, RESTAURANT, COMMERCIAL SPACES (GROUND LEVEL), BAR, GYM AND OUTDOOR POOL. 4TH LEVEL CONTAINS OPEN AIR POOL AREA AND RESTAURANT/BAR AREAS.	PROJECT LOCATION

PA22-0929, PA22-0930, PA22-0931 SUBMITTAL #5



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APN: 922-100-048


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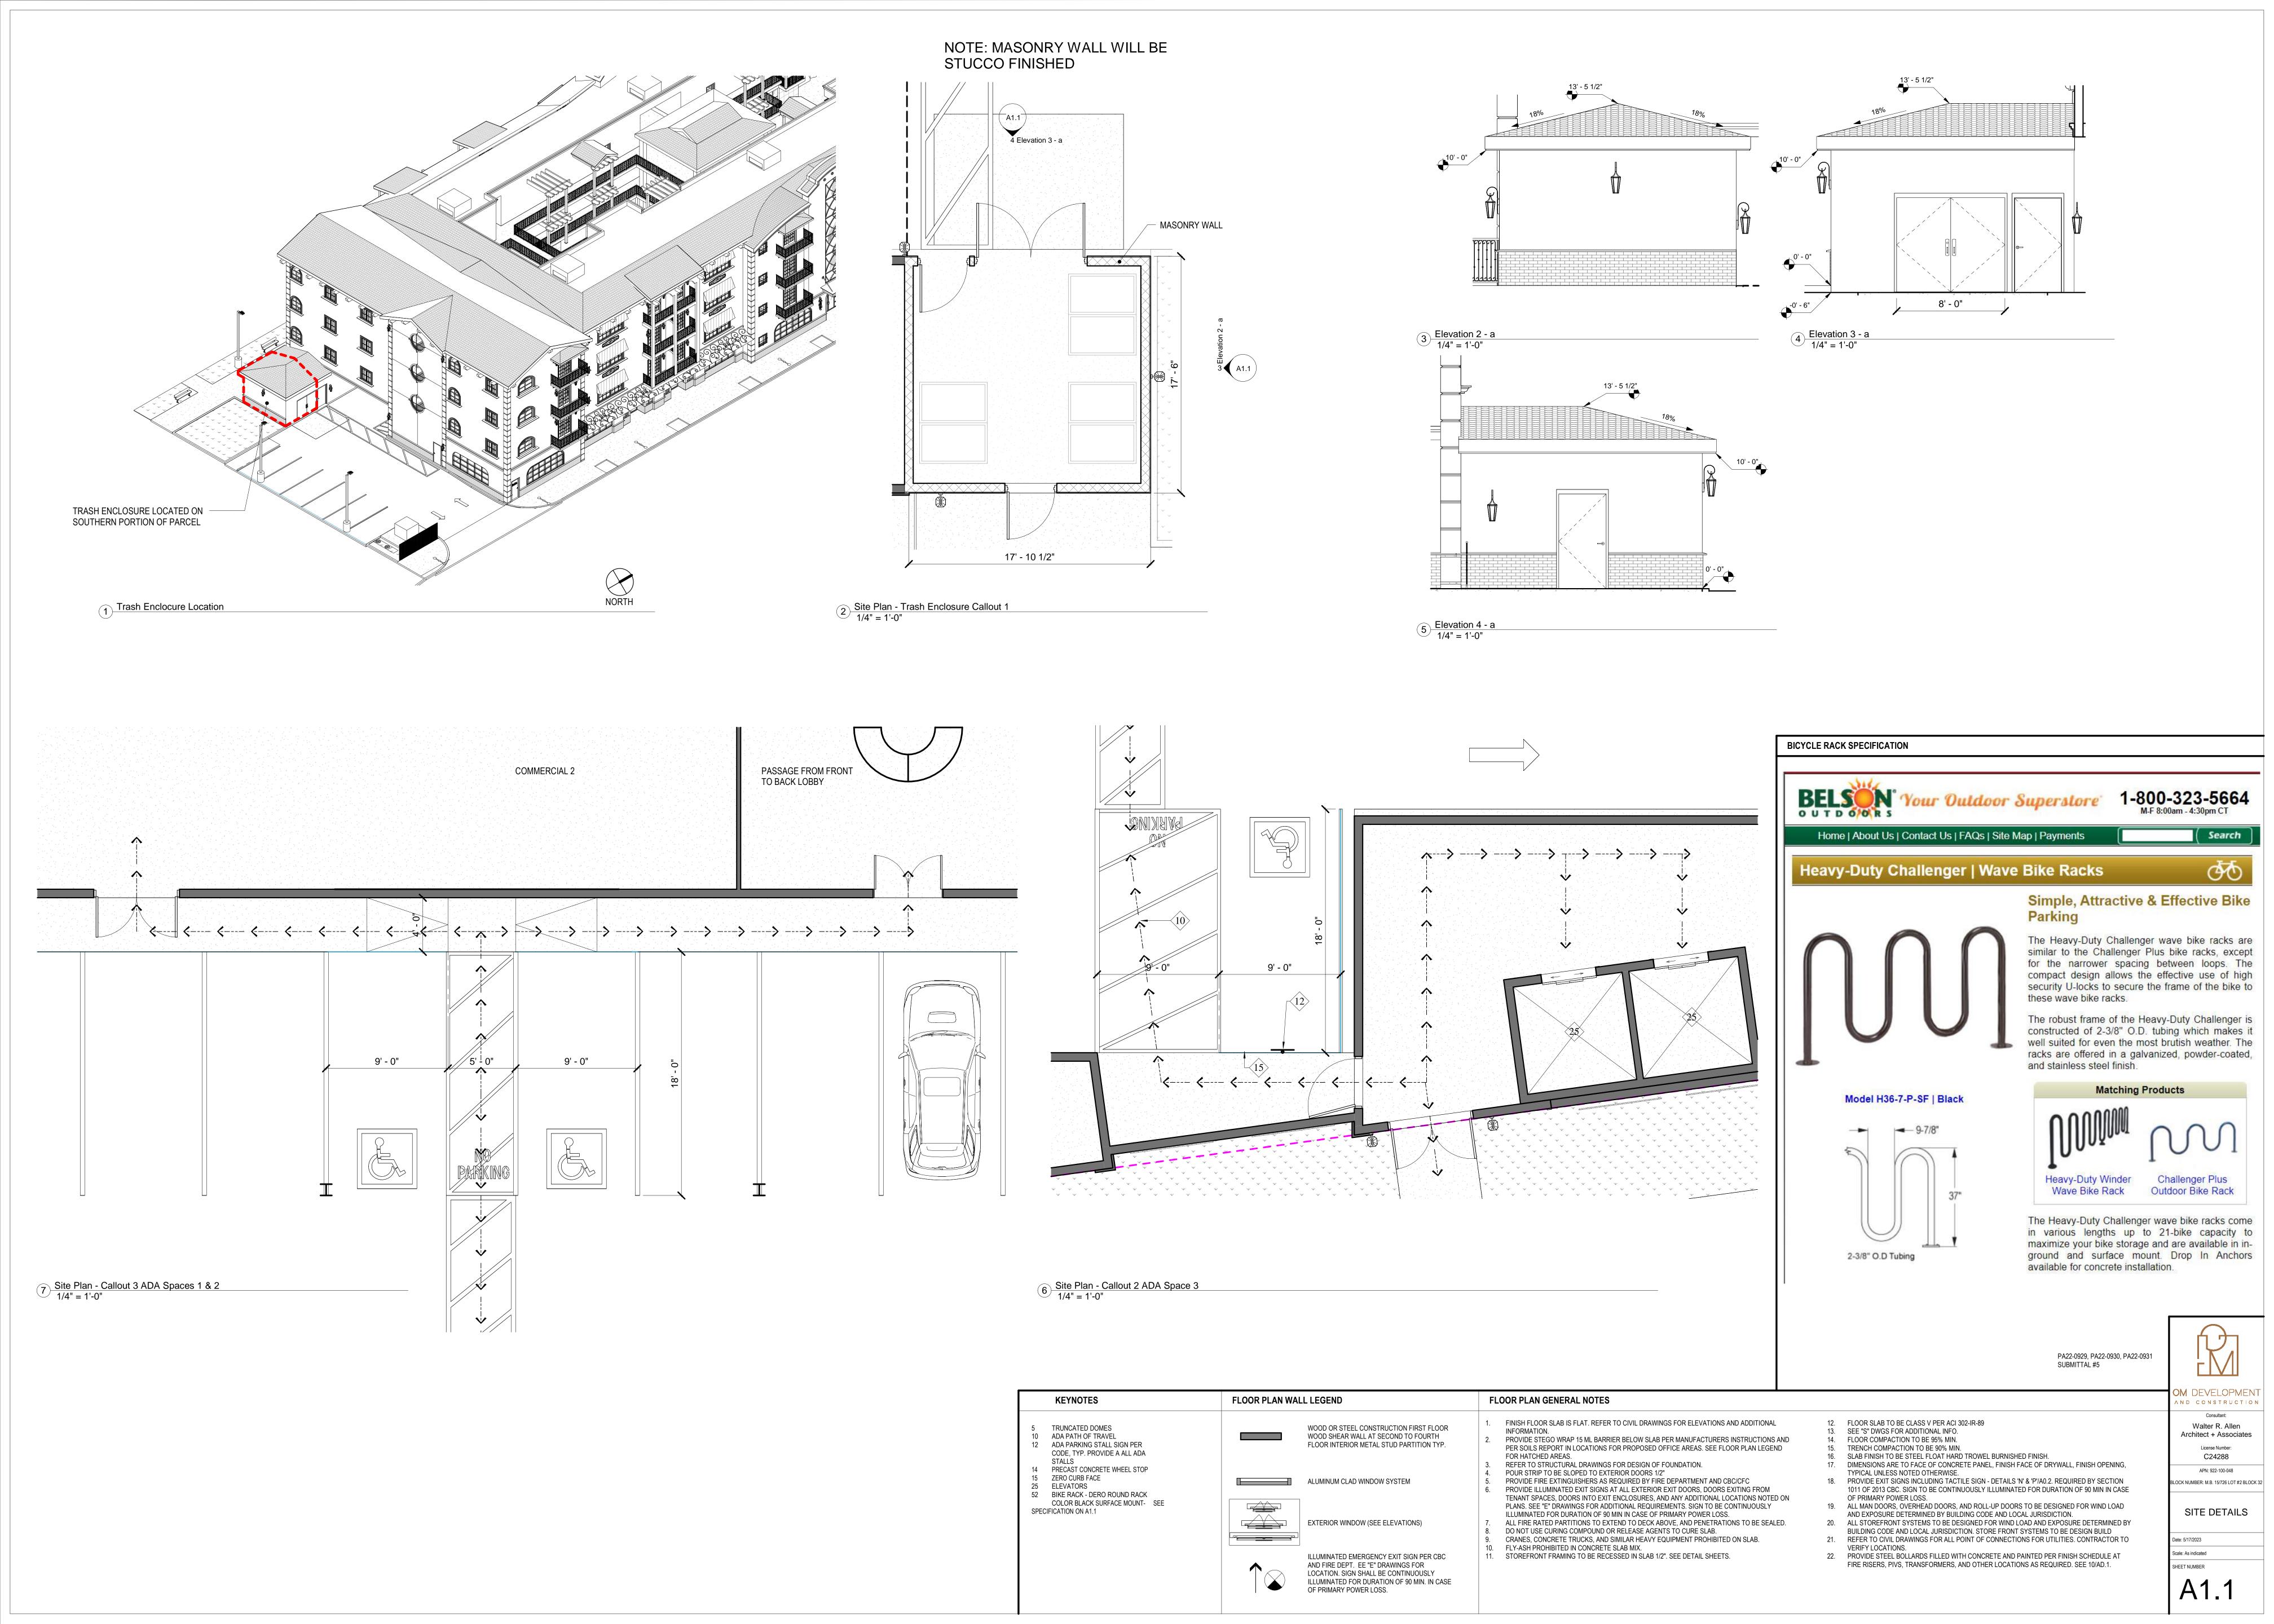
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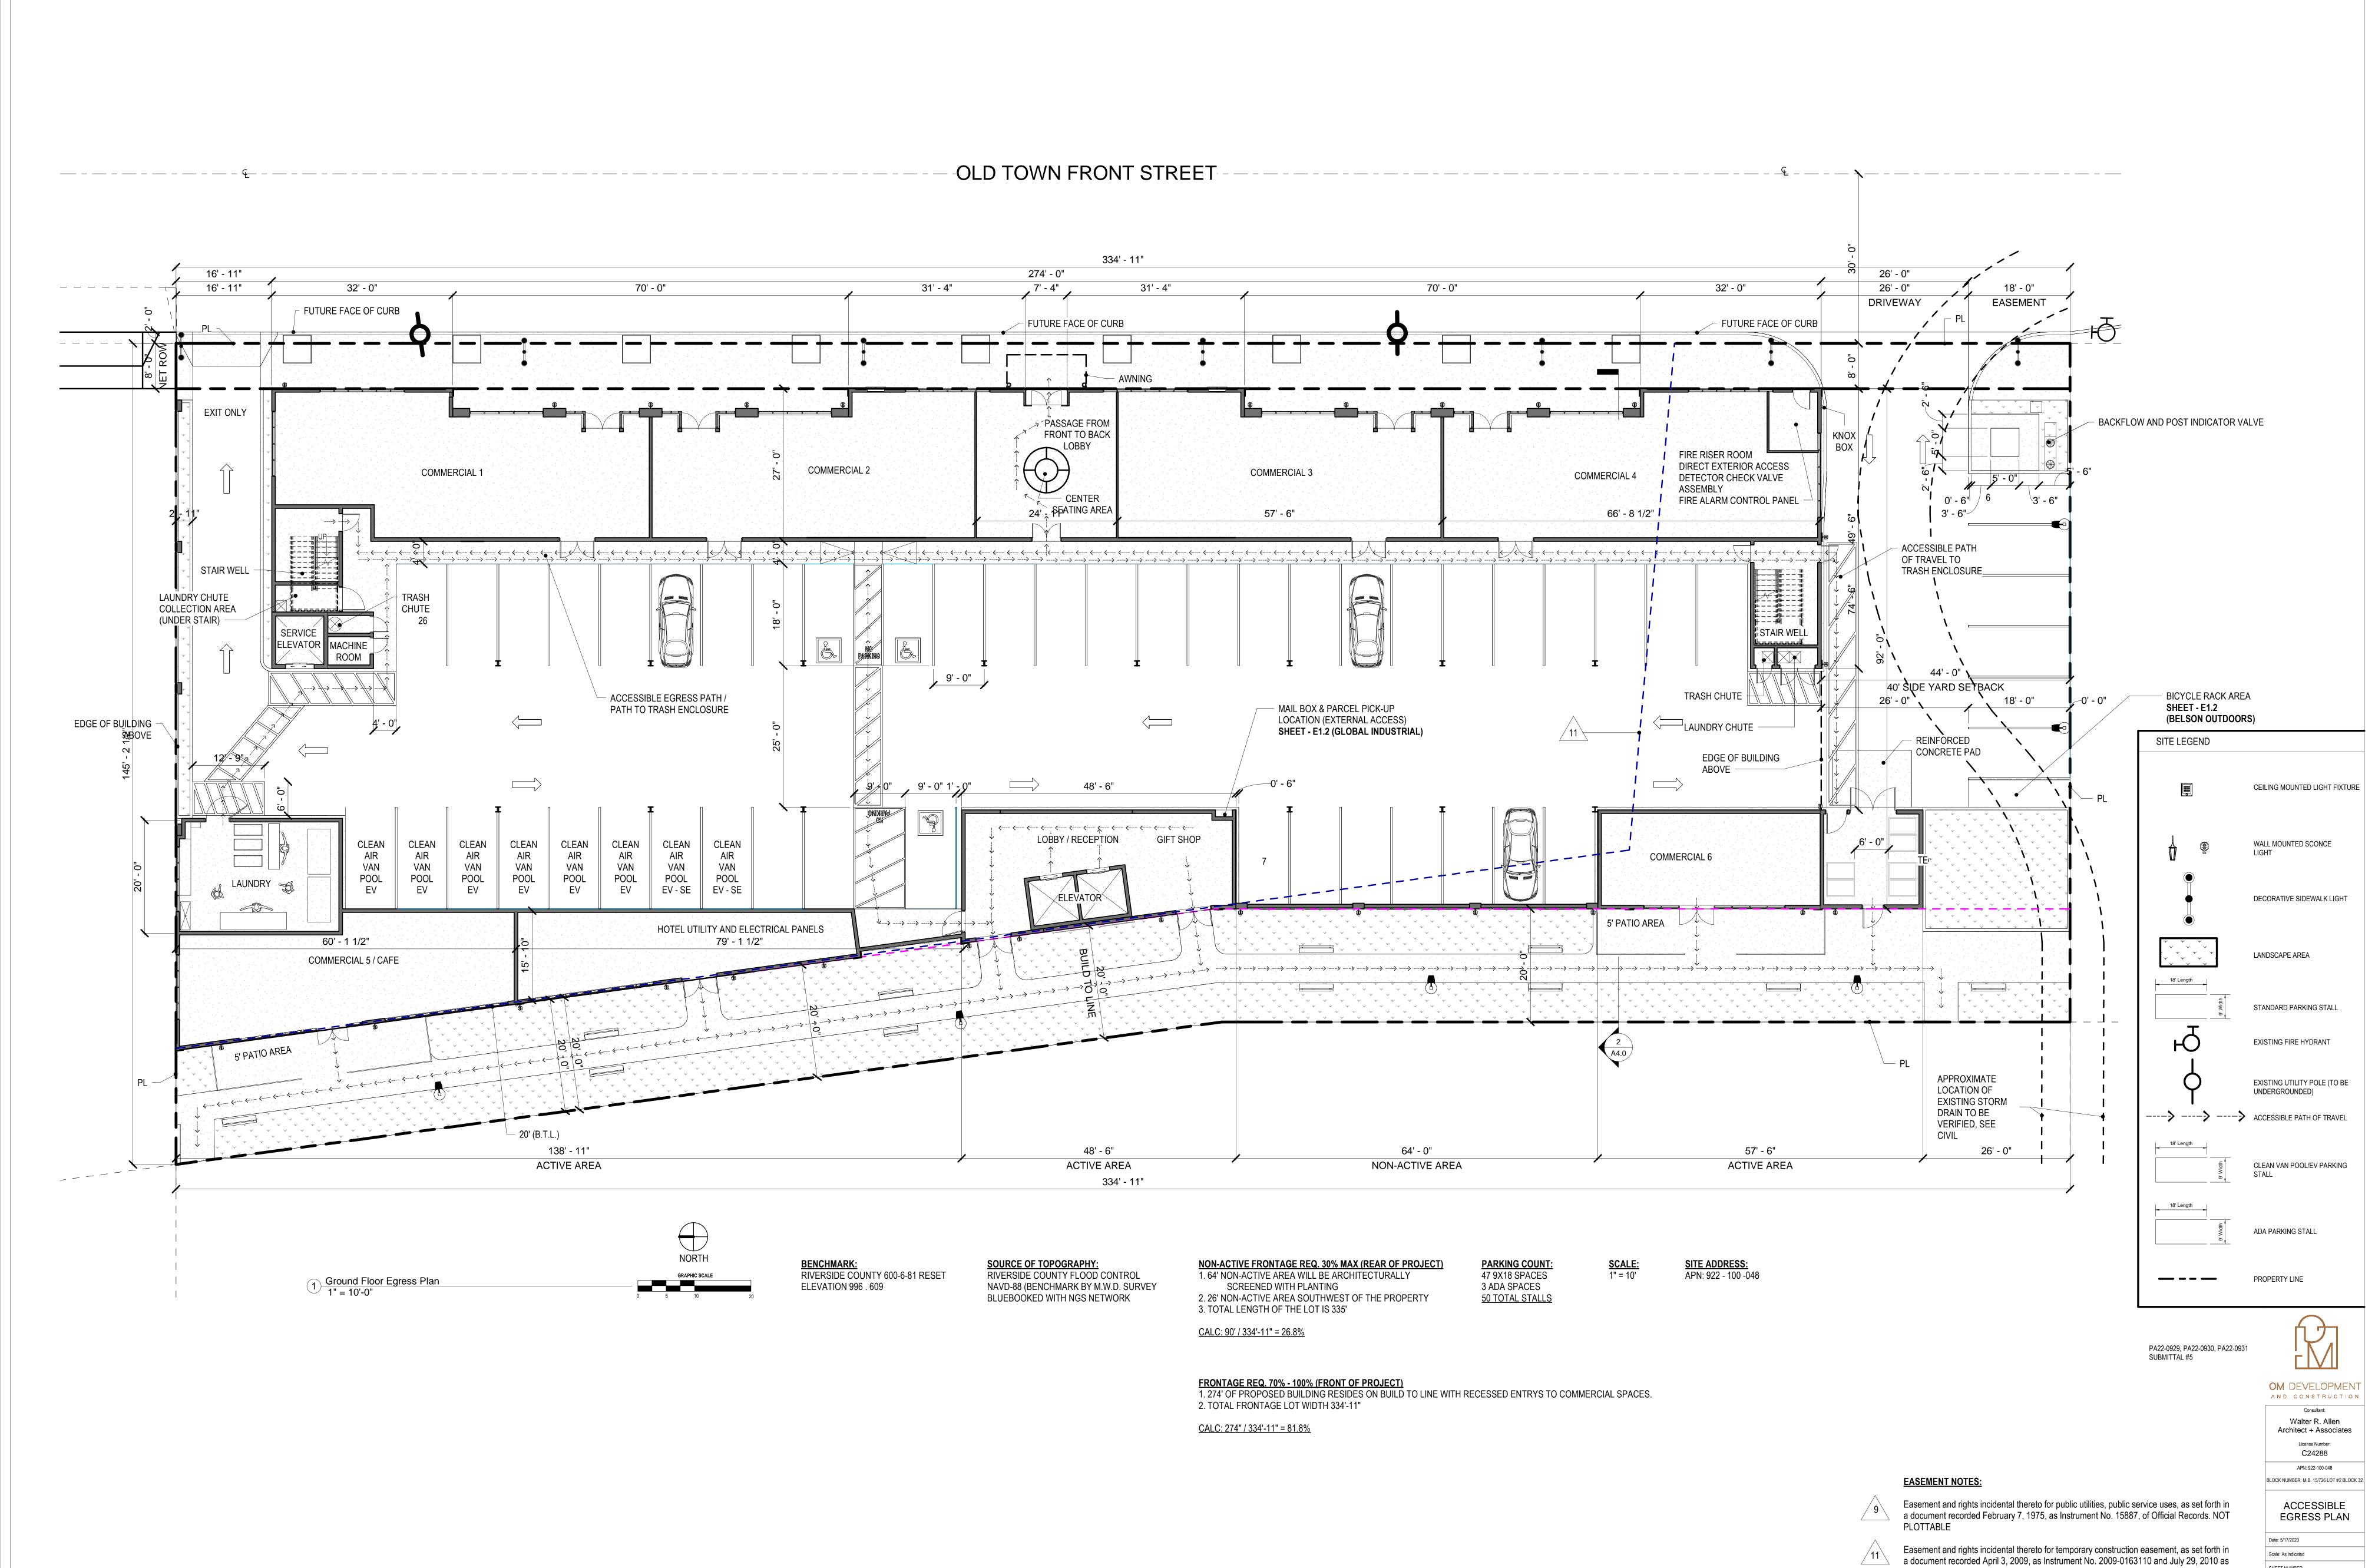
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SHEET NUMBER

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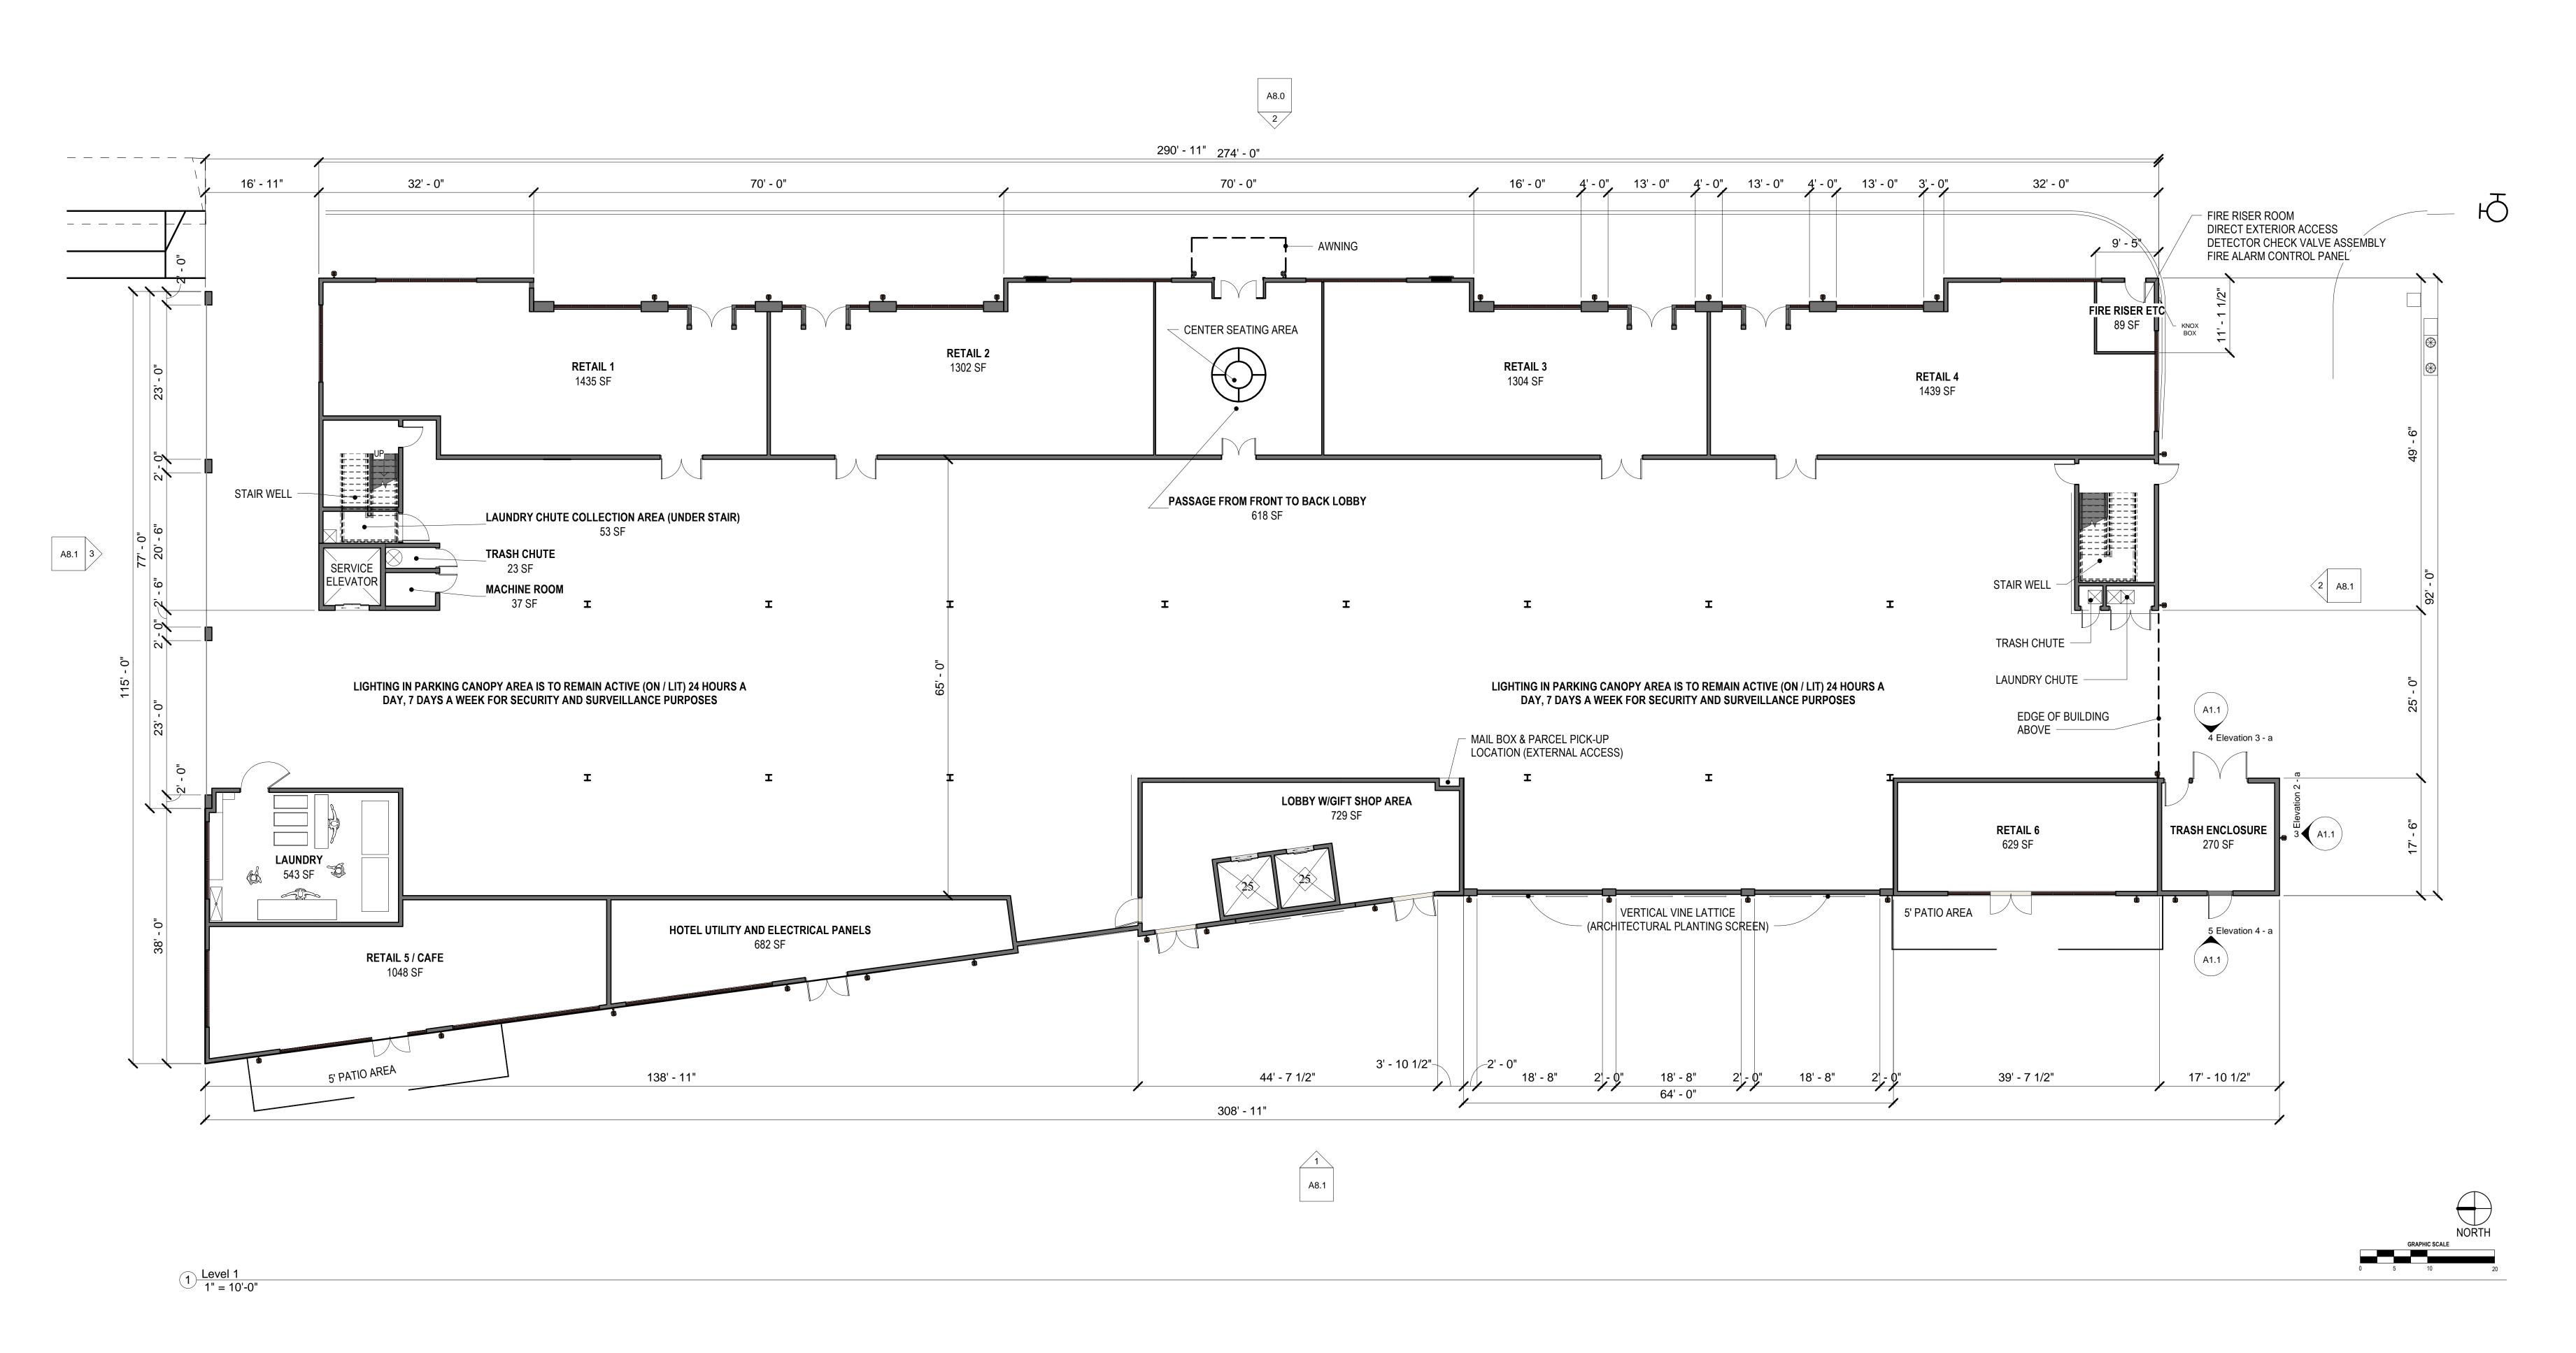




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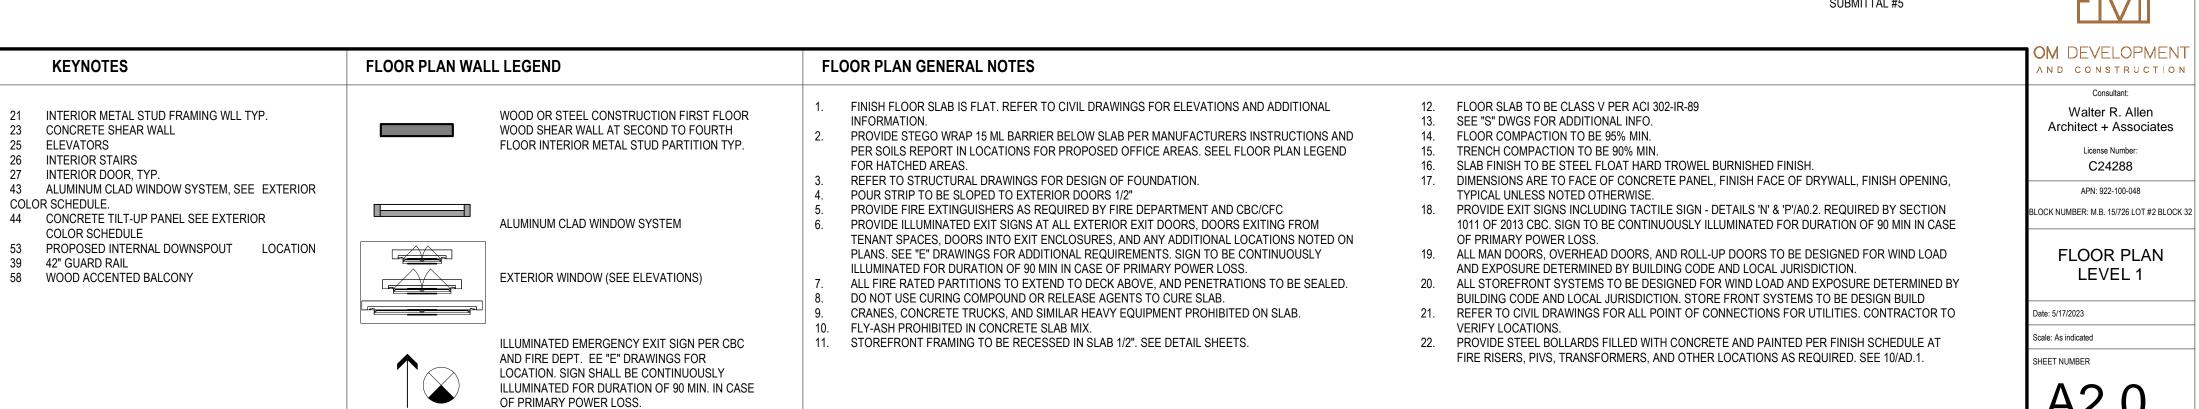
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Instrument No. 2010-0355371, both of Official Records. (TO BE VACATED)

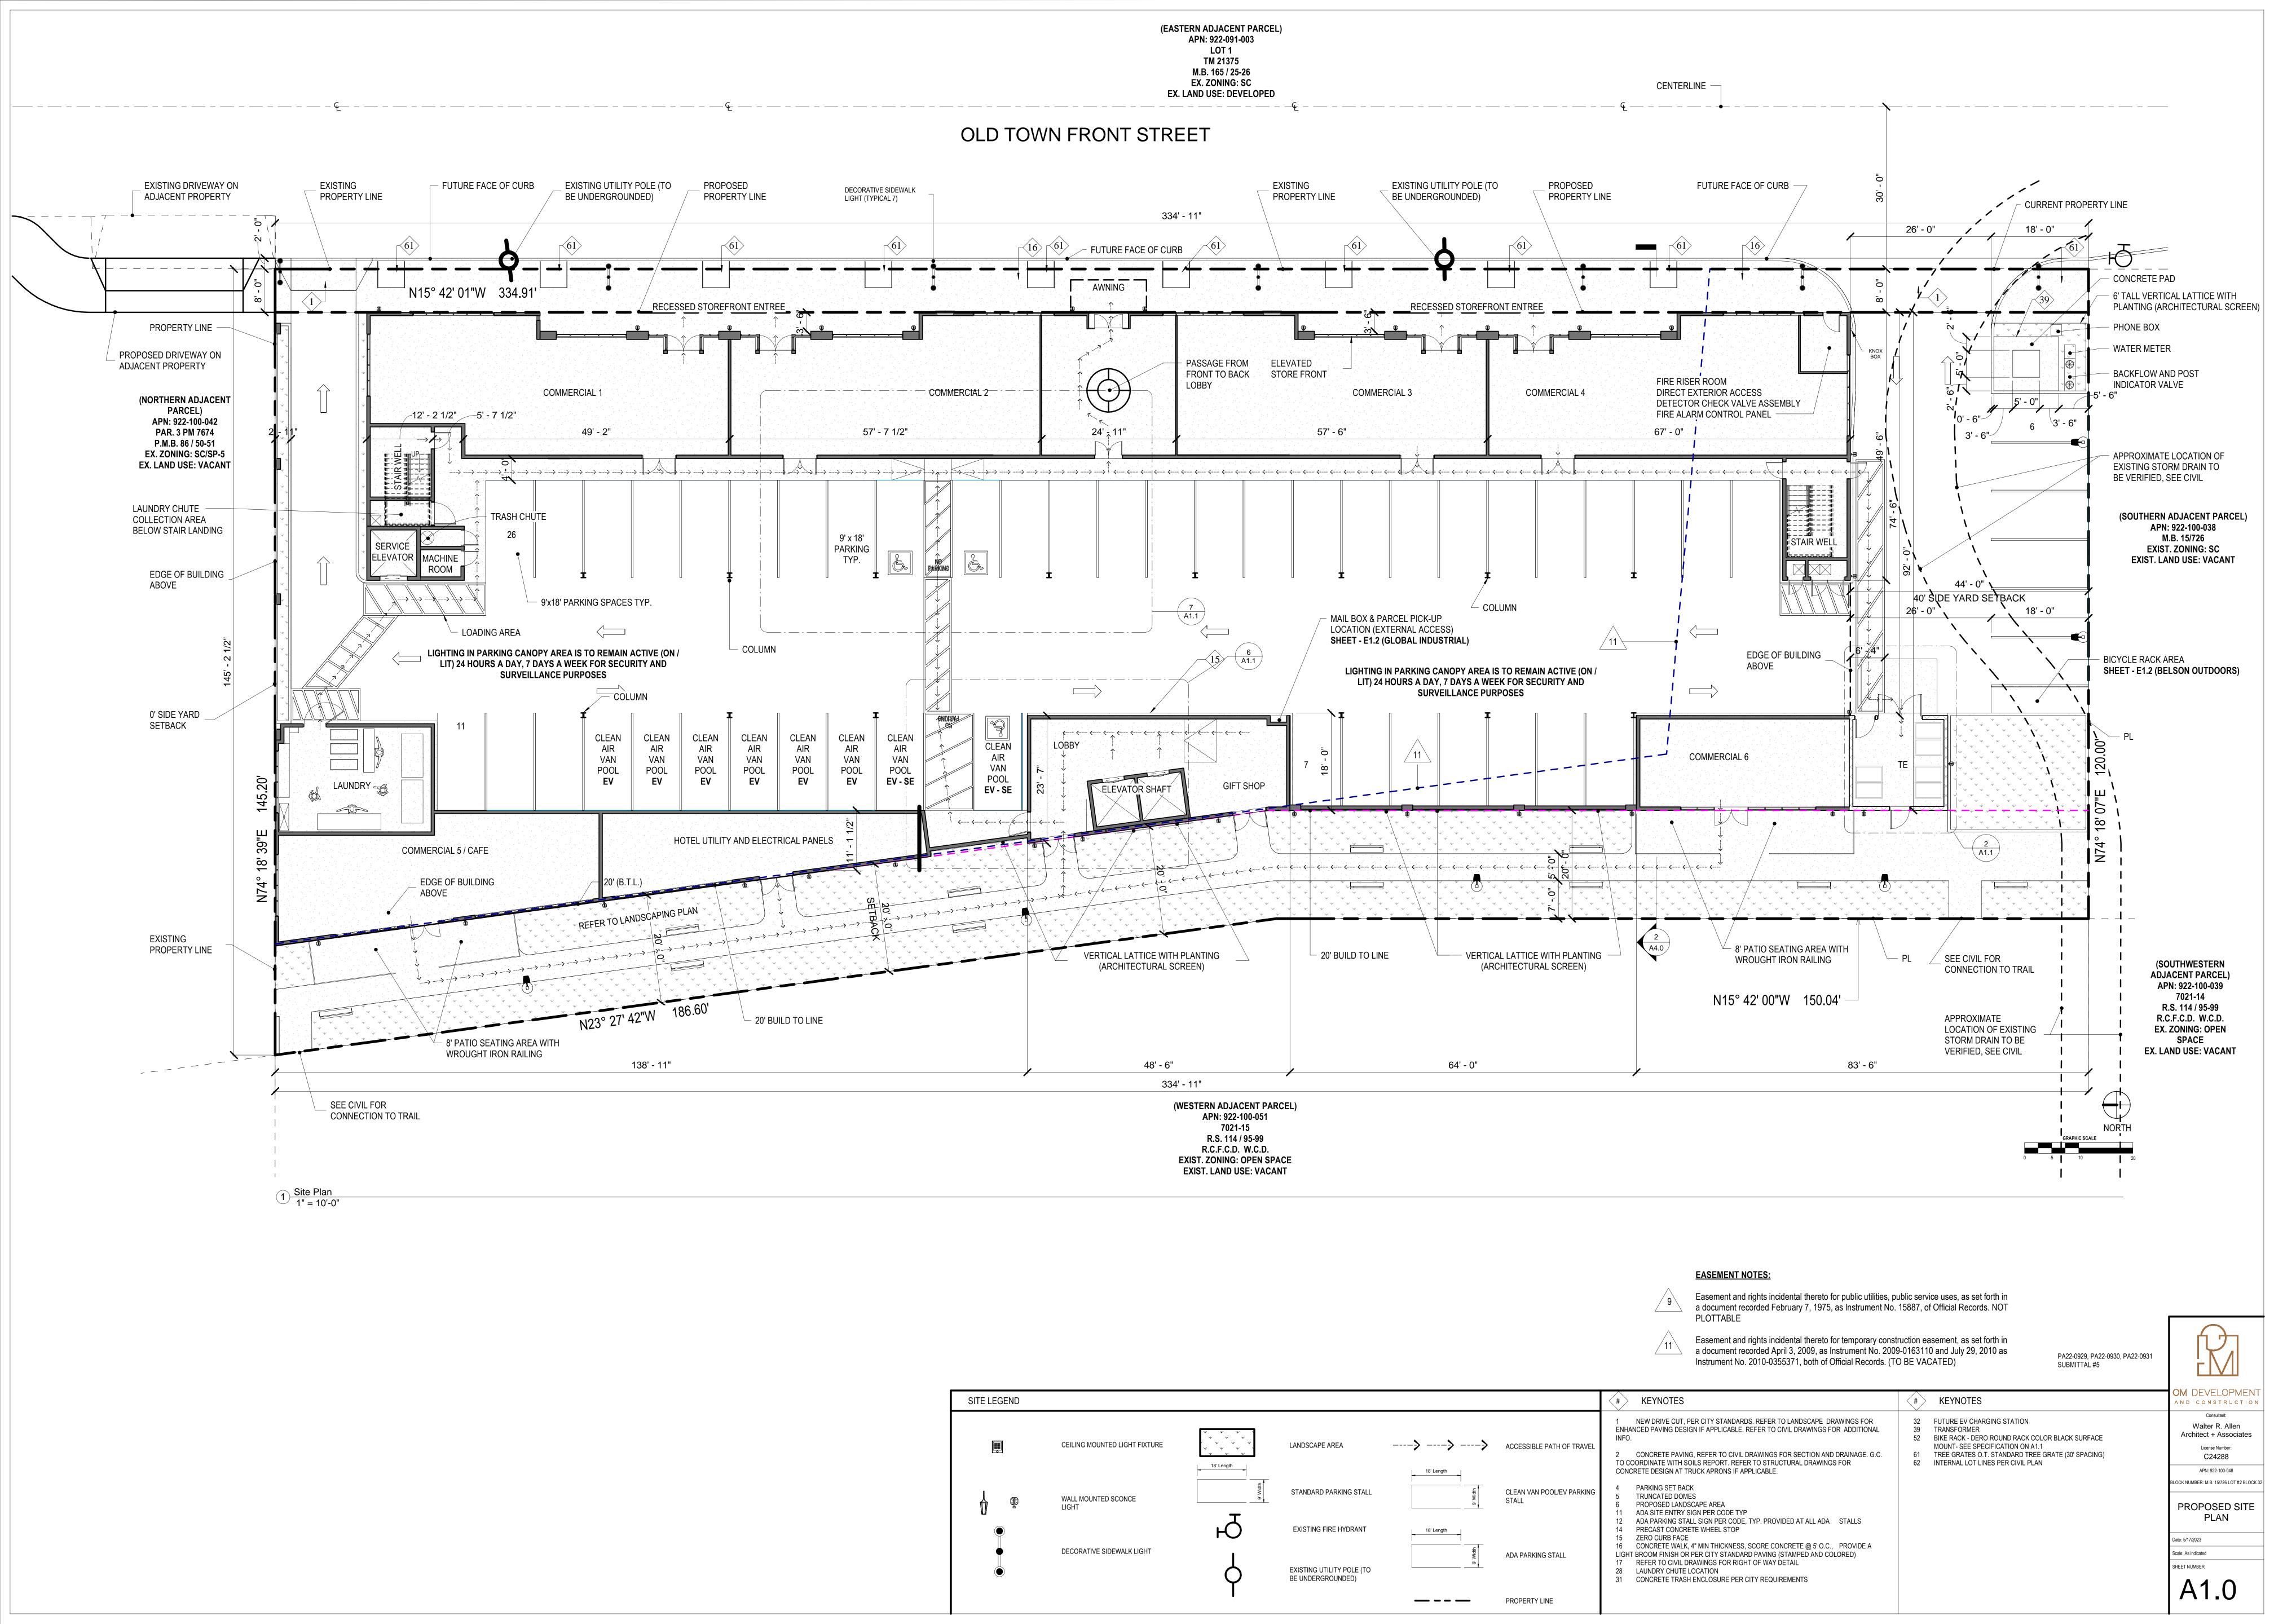


PA22-0929, PA22-0930, PA22-0931 SUBMITTAL #5







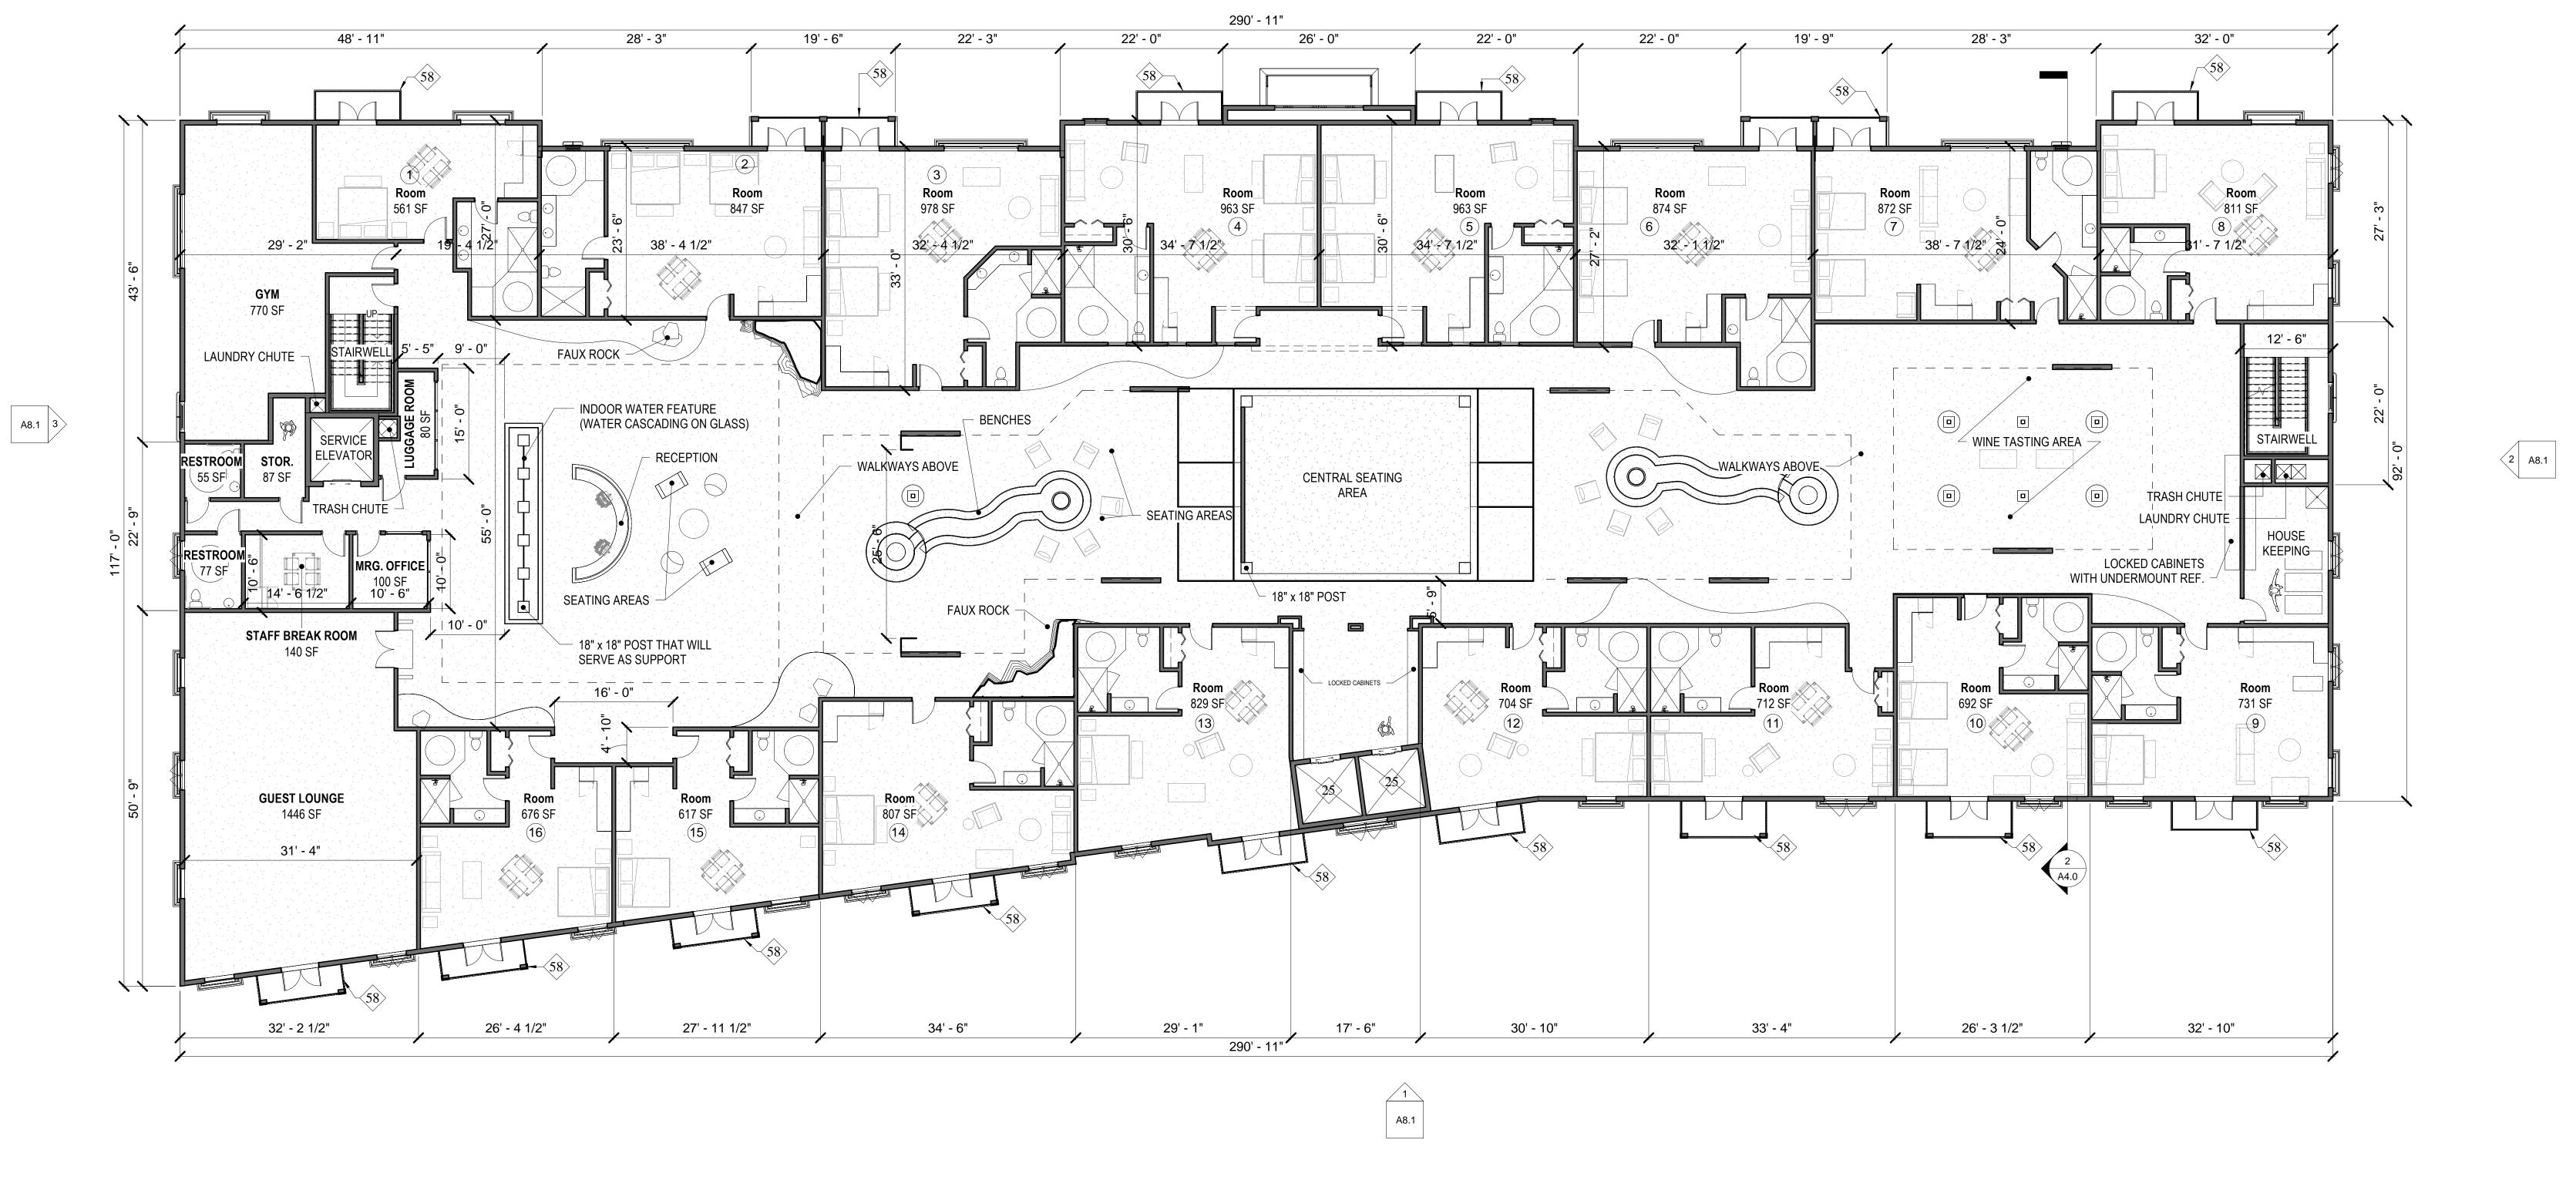


NORTH

GRAPHIC SCALE

0 5 10 20

1 Level 2 1" = 10'-0"

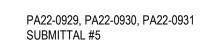



Walter R. Allen

Architect + Associates

License Number:

C24288

APN: 922-100-048

BLOCK NUMBER: M.B. 15/726 LOT #2 BLOCK 32

FLOOR PLAN

LEVEL 2

Date: 5/17/2023

Scale: As indicated


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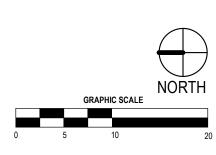
KEYNOTES	FLOOR PLAN WALL LEGEND	FLOOR PLAN GENERAL NOTES	
21 INTERIOR METAL STUD FRAMING WLL TYP. 23 CONCRETE SHEAR WALL 25 ELEVATORS 26 INTERIOR STAIRS 27 INTERIOR DOOR, TYP. 43 ALUMINUM CLAD WINDOW SYSTEM, SEE EXTERIOR	WOOD OR STEEL CONSTRUCTION FIRST FLOOR WOOD SHEAR WALL AT SECOND TO FOURTH FLOOR INTERIOR METAL STUD PARTITION TYP.	 FINISH FLOOR SLAB IS FLAT. REFER TO CIVIL DRAWINGS FOR ELEVATIONS AND ADDITIONAL INFORMATION. PROVIDE STEGO WRAP 15 ML BARRIER BELOW SLAB PER MANUFACTURERS INSTRUCTIONS AND PER SOILS REPORT IN LOCATIONS FOR PROPOSED OFFICE AREAS. SEEL FLOOR PLAN LEGEND FOR HATCHED AREAS. REFER TO STRUCTURAL DRAWINGS FOR DESIGN OF FOUNDATION. POUR STRIP TO BE SLOPED TO EXTERIOR DOORS 1/2" 	 FLOOR SLAB TO BE CLASS V PER ACI 302-IR-89 SEE "S" DWGS FOR ADDITIONAL INFO. FLOOR COMPACTION TO BE 95% MIN. TRENCH COMPACTION TO BE 90% MIN. SLAB FINISH TO BE STEEL FLOAT HARD TROWEL BURNISHED FINISH. DIMENSIONS ARE TO FACE OF CONCRETE PANEL, FINISH FACE OF DRYWALL, FINISH OPENING, TYPICAL UNLESS NOTED OTHERWISE.
COLOR SCHEDULE. 44 CONCRETE TILT-UP PANEL SEE EXTERIOR COLOR SCHEDULE	ALUMINUM CLAD WINDOW SYSTEM	 PROVIDE FIRE EXTINGUISHERS AS REQUIRED BY FIRE DEPARTMENT AND CBC/CFC PROVIDE ILLUMINATED EXIT SIGNS AT ALL EXTERIOR EXIT DOORS, DOORS EXITING FROM TENANT SPACES, DOORS INTO EXIT ENCLOSURES, AND ANY ADDITIONAL LOCATIONS NOTED ON 	18. PROVIDE EXIT SIGNS INCLUDING TACTILE SIGN - DETAILS 'N' & 'P'/A0.2. REQUIRED BY SECTION 1011 OF 2013 CBC. SIGN TO BE CONTINUOUSLY ILLUMINATED FOR DURATION OF 90 MIN IN CASE OF PRIMARY POWER LOSS.
53 PROPOSED INTERNAL DOWNSPOUT LOCATION 39 42" GUARD RAIL 58 WOOD ACCENTED BALCONY	EXTERIOR WINDOW (SEE ELEVATIONS)	PLANS. SEE "E" DRAWINGS FOR ADDITIONAL REQUIREMENTS. SIGN TO BE CONTINUOUSLY ILLUMINATED FOR DURATION OF 90 MIN IN CASE OF PRIMARY POWER LOSS. 7. ALL FIRE RATED PARTITIONS TO EXTEND TO DECK ABOVE, AND PENETRATIONS TO BE SEALED. 8. DO NOT USE CURING COMPOUND OR RELEASE AGENTS TO CURE SLAB. 9. CRANES, CONCRETE TRUCKS, AND SIMILAR HEAVY EQUIPMENT PROHIBITED ON SLAB.	 ALL MAN DOORS, OVERHEAD DOORS, AND ROLL-UP DOORS TO BE DESIGNED FOR WIND LOAD AND EXPOSURE DETERMINED BY BUILDING CODE AND LOCAL JURISDICTION. ALL STOREFRONT SYSTEMS TO BE DESIGNED FOR WIND LOAD AND EXPOSURE DETERMINED BY BUILDING CODE AND LOCAL JURISDICTION. STORE FRONT SYSTEMS TO BE DESIGN BUILD REFER TO CIVIL DRAWINGS FOR ALL POINT OF CONNECTIONS FOR UTILITIES. CONTRACTOR TO
	ILLUMINATED EMERGENCY EXIT SIGN PER CBC AND FIRE DEPT. EE "E" DRAWINGS FOR	 10. FLY-ASH PROHIBITED IN CONCRETE SLAB MIX. 11. STOREFRONT FRAMING TO BE RECESSED IN SLAB 1/2". SEE DETAIL SHEETS. 	VERIFY LOCATIONS. 22. PROVIDE STEEL BOLLARDS FILLED WITH CONCRETE AND PAINTED PER FINISH SCHEDULE AT FIRE RISERS, PIVS, TRANSFORMERS, AND OTHER LOCATIONS AS REQUIRED. SEE 10/AD.1.

LOCATION. SIGN SHALL BE CONTINUOUSLY


ILLUMINATED FOR DURATION OF 90 MIN. IN CASE OF PRIMARY POWER LOSS.

NOTE: AVERAGE ROOM SQUARE FOOTAGE IS 800 SF



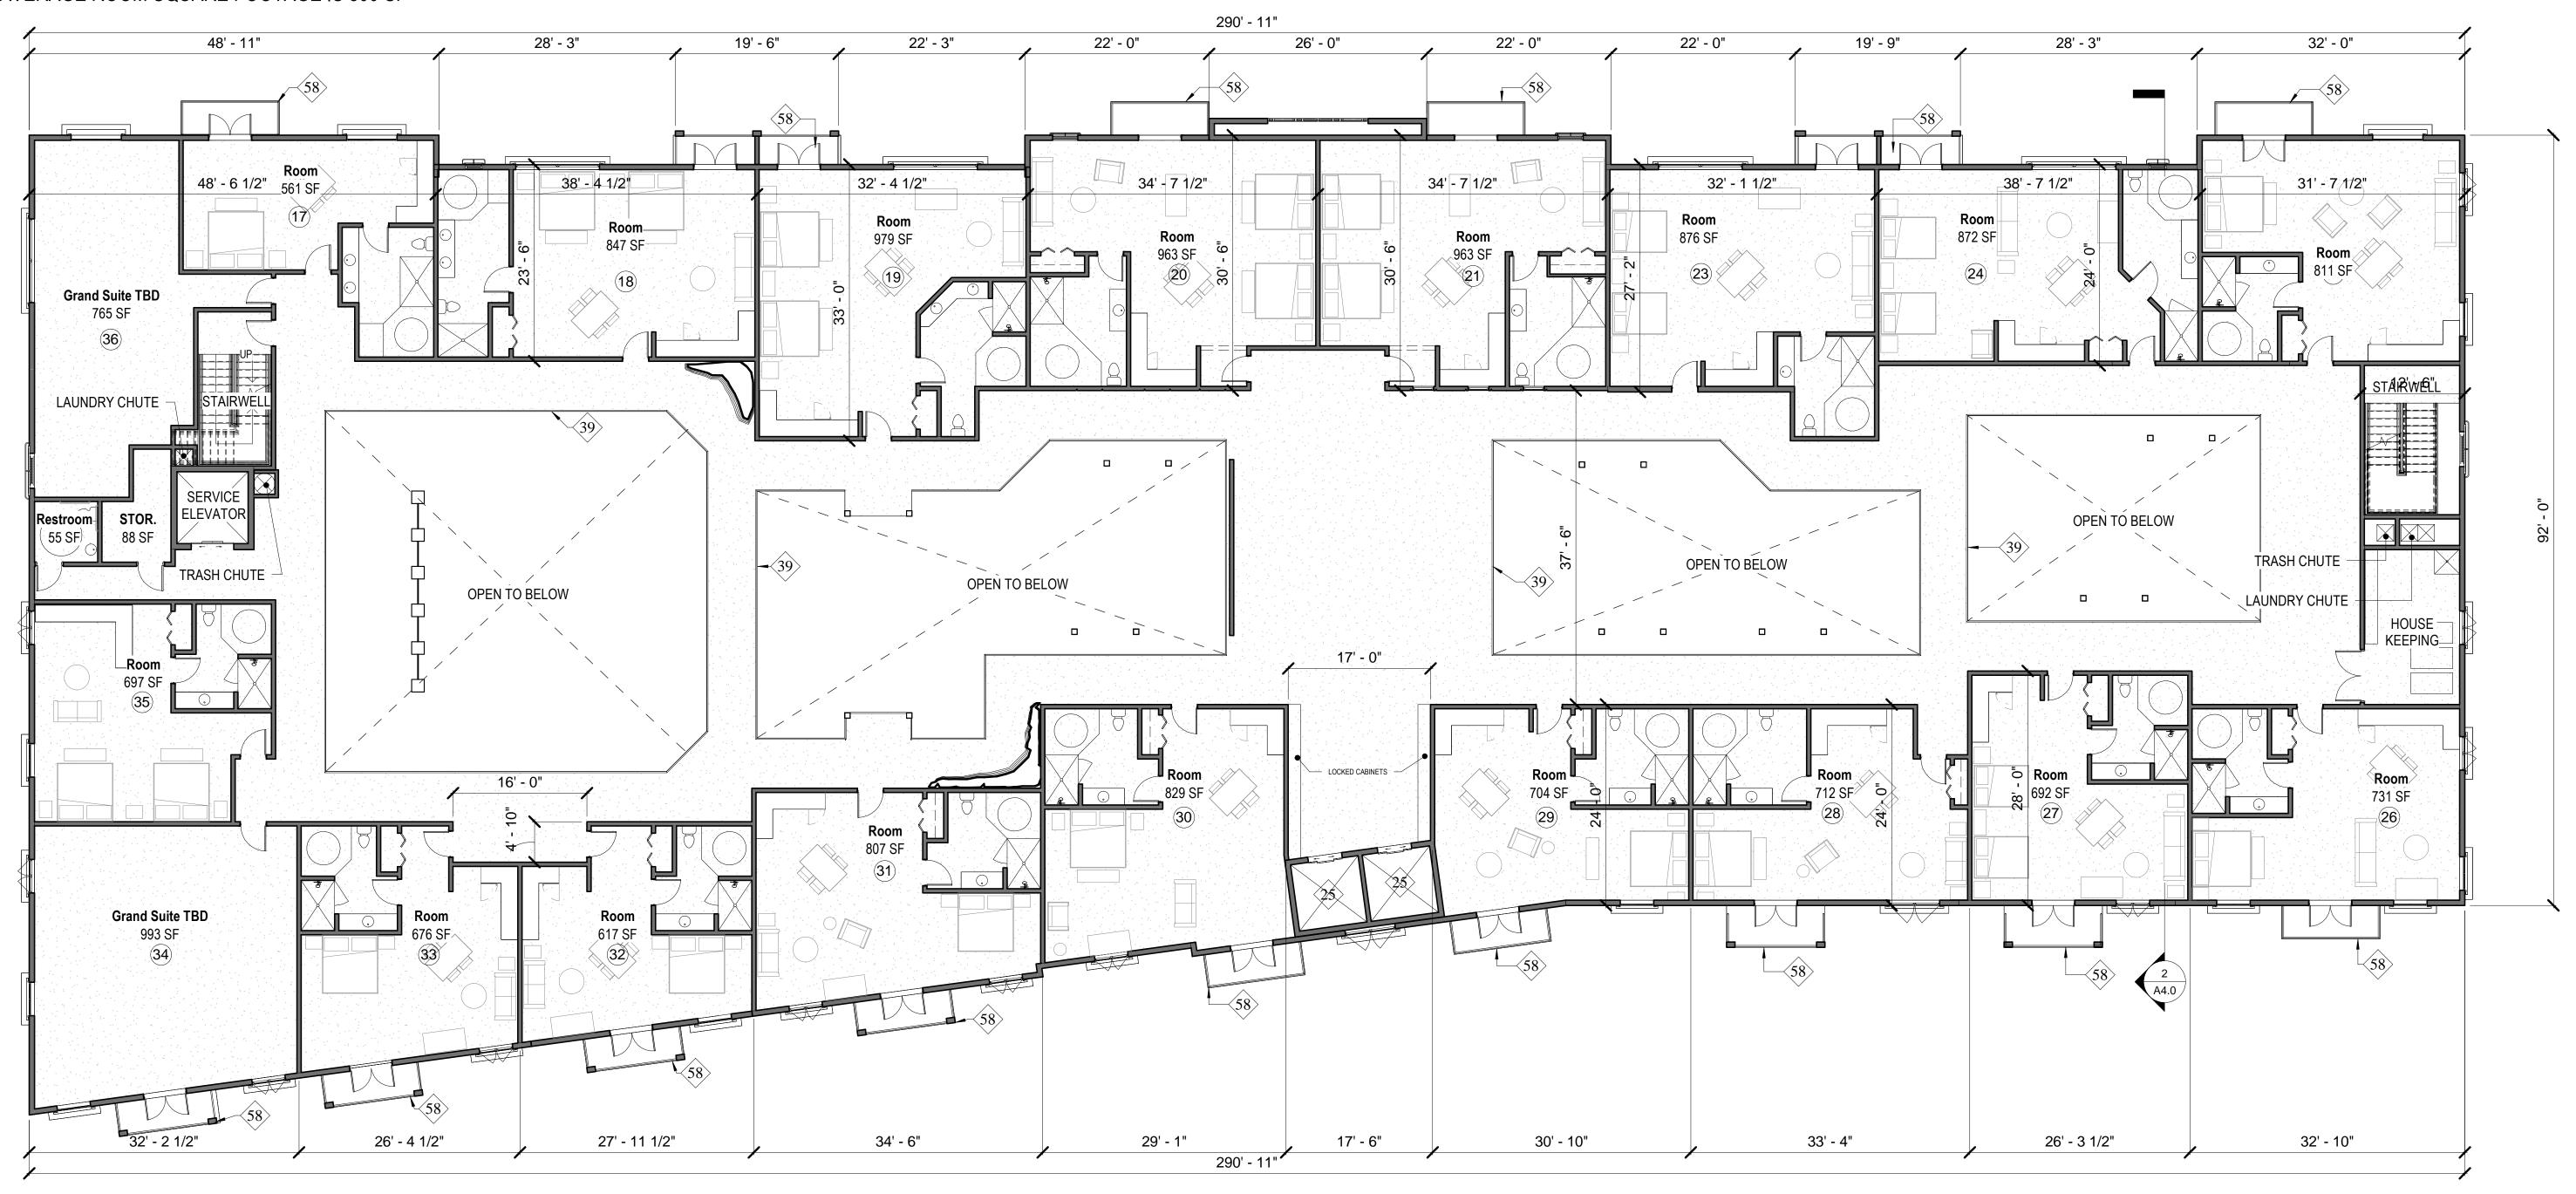

1 Level 3 1" = 10'-0"

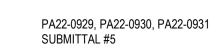

ND CONSTRUCTION Consultant:

21 INTERIOR METAL STUD FRAMING WLL TYP. WOOD OR STEEL CONSTRUCTION FIRST FLOOR 23 CONCRETE SHEAR WALL WOOD SHEAR WALL AT SECOND TO FOURTH 25 ELEVATORS FLOOR INTERIOR METAL STUD PARTITION TYP. 26 INTERIOR STAIRS 27 INTERIOR DOOR, TYP. 43 ALUMINUM CLAD WINDOW SYSTEM, SEE EXTERIOR COLOR SCHEDULE. 44 CONCRETE TILT-UP PANEL SEE EXTERIOR ALUMINUM CLAD WINDOW SYSTEM **COLOR SCHEDULE** 53 PROPOSED INTERNAL DOWNSPOUT LOCATION 39 42" GUARD RAIL 58 WOOD ACCENTED BALCONY EXTERIOR WINDOW (SEE ELEVATIONS) 9. CRANES, CONCRETE TRUCKS, AND SIMILAR HEAVY EQUIPMENT PROHIBITED ON SLAB. 10. FLY-ASH PROHIBITED IN CONCRETE SLAB MIX. 11. STOREFRONT FRAMING TO BE RECESSED IN SLAB 1/2". SEE DETAIL SHEETS. ILLUMINATED EMERGENCY EXIT SIGN PER CBC AND FIRE DEPT. EE "E" DRAWINGS FOR LOCATION. SIGN SHALL BE CONTINUOUSLY

ILLUMINATED FOR DURATION OF 90 MIN. IN CASE

OF PRIMARY POWER LOSS.

FLOOR PLAN WALL LEGEND

KEYNOTES

FINISH FLOOR SLAB IS FLAT. REFER TO CIVIL DRAWINGS FOR ELEVATIONS AND ADDITIONAL INFORMATION. PROVIDE STEGO WRAP 15 ML BARRIER BELOW SLAB PER MANUFACTURERS INSTRUCTIONS AND PER SOILS REPORT IN LOCATIONS FOR PROPOSED OFFICE AREAS. SEEL FLOOR PLAN LEGEND FOR HATCHED AREAS.

FLOOR PLAN GENERAL NOTES

REFER TO STRUCTURAL DRAWINGS FOR DESIGN OF FOUNDATION. POUR STRIP TO BE SLOPED TO EXTERIOR DOORS 1/2" PROVIDE FIRE EXTINGUISHERS AS REQUIRED BY FIRE DEPARTMENT AND CBC/CFC PROVIDE ILLUMINATED EXIT SIGNS AT ALL EXTERIOR EXIT DOORS, DOORS EXITING FROM TENANT SPACES, DOORS INTO EXIT ENCLOSURES, AND ANY ADDITIONAL LOCATIONS NOTED ON

PLANS. SEE "E" DRAWINGS FOR ADDITIONAL REQUIREMENTS. SIGN TO BE CONTINUOUSLY ILLUMINATED FOR DURATION OF 90 MIN IN CASE OF PRIMARY POWER LOSS. ALL FIRE RATED PARTITIONS TO EXTEND TO DECK ABOVE, AND PENETRATIONS TO BE SEALED. 8. DO NOT USE CURING COMPOUND OR RELEASE AGENTS TO CURE SLAB.

TRENCH COMPACTION TO BE 90% MIN. 16. SLAB FINISH TO BE STEEL FLOAT HARD TROWEL BURNISHED FINISH. DIMENSIONS ARE TO FACE OF CONCRETE PANEL, FINISH FACE OF DRYWALL, FINISH OPENING, TYPICAL UNLESS NOTED OTHERWISE. 18. PROVIDE EXIT SIGNS INCLUDING TACTILE SIGN - DETAILS 'N' & 'P'/A0.2. REQUIRED BY SECTION 1011 OF 2013 CBC. SIGN TO BE CONTINUOUSLY ILLUMINATED FOR DURATION OF 90 MIN IN CASE

FLOOR SLAB TO BE CLASS V PER ACI 302-IR-89

SEE "S" DWGS FOR ADDITIONAL INFO.

FLOOR COMPACTION TO BE 95% MIN.

OF PRIMARY POWER LOSS. 19. ALL MAN DOORS, OVERHEAD DOORS, AND ROLL-UP DOORS TO BE DESIGNED FOR WIND LOAD AND EXPOSURE DETERMINED BY BUILDING CODE AND LOCAL JURISDICTION. 20. ALL STOREFRONT SYSTEMS TO BE DESIGNED FOR WIND LOAD AND EXPOSURE DETERMINED BY

FIRE RISERS, PIVS, TRANSFORMERS, AND OTHER LOCATIONS AS REQUIRED. SEE 10/AD.1.

BUILDING CODE AND LOCAL JURISDICTION. STORE FRONT SYSTEMS TO BE DESIGN BUILD 21. REFER TO CIVIL DRAWINGS FOR ALL POINT OF CONNECTIONS FOR UTILITIES. CONTRACTOR TO VERIFY LOCATIONS. 22. PROVIDE STEEL BOLLARDS FILLED WITH CONCRETE AND PAINTED PER FINISH SCHEDULE AT

Date: 5/17/2023 Scale: As indicated SHEET NUMBER

Walter R. Allen

Architect + Associates

License Number:


C24288

APN: 922-100-048

BLOCK NUMBER: M.B. 15/726 LOT #2 BLOCK 32

FLOOR PLAN

LEVEL 3

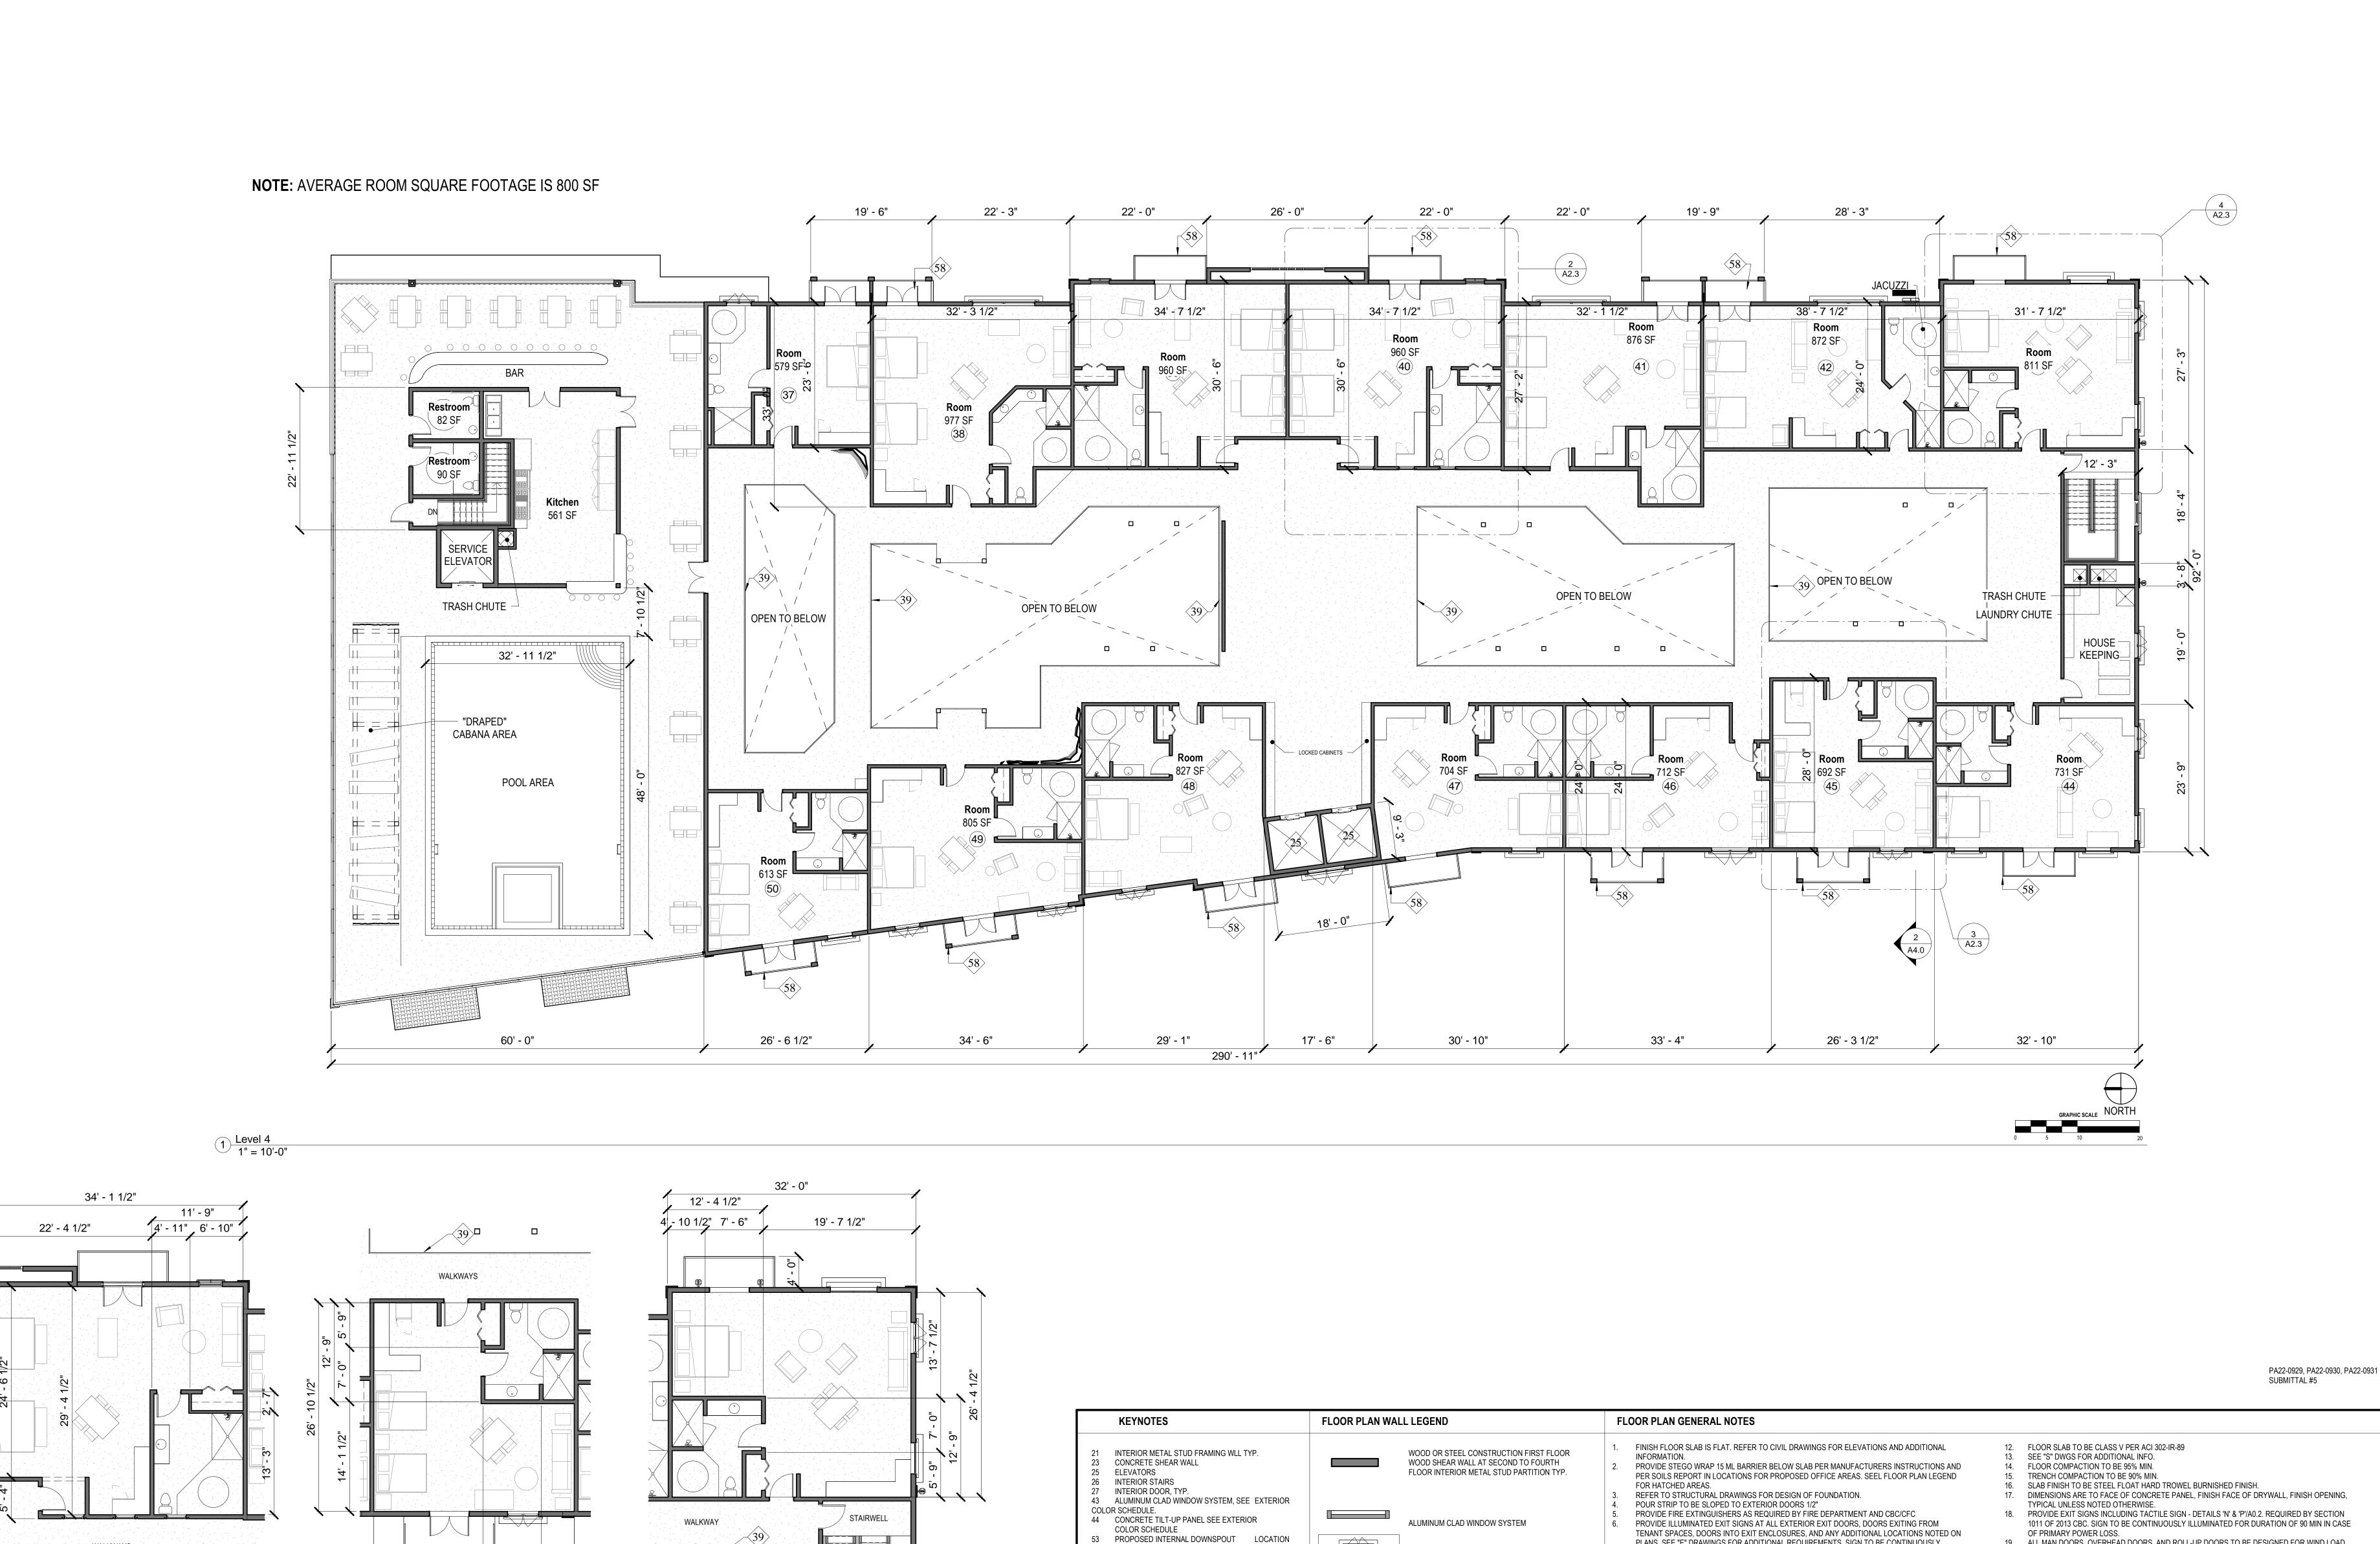

39 42" GUARD RAIL

58 WOOD ACCENTED BALCONY

WALKWAYS

14' - 0 1/2"

25' - 9**^**1/2"

ND CONSTRUCTION Consultant: Walter R. Allen Architect + Associates License Number: C24288 APN: 922-100-048 BLOCK NUMBER: M.B. 15/726 LOT #2 BLOCK 32

19. ALL MAN DOORS, OVERHEAD DOORS, AND ROLL-UP DOORS TO BE DESIGNED FOR WIND LOAD AND EXPOSURE DETERMINED BY BUILDING CODE AND LOCAL JURISDICTION. 20. ALL STOREFRONT SYSTEMS TO BE DESIGNED FOR WIND LOAD AND EXPOSURE DETERMINED BY BUILDING CODE AND LOCAL JURISDICTION. STORE FRONT SYSTEMS TO BE DESIGN BUILD

VERIFY LOCATIONS.

PLANS. SEE "E" DRAWINGS FOR ADDITIONAL REQUIREMENTS. SIGN TO BE CONTINUOUSLY

ALL FIRE RATED PARTITIONS TO EXTEND TO DECK ABOVE, AND PENETRATIONS TO BE SEALED.

ILLUMINATED FOR DURATION OF 90 MIN IN CASE OF PRIMARY POWER LOSS.

9. CRANES, CONCRETE TRUCKS, AND SIMILAR HEAVY EQUIPMENT PROHIBITED ON SLAB.

DO NOT USE CURING COMPOUND OR RELEASE AGENTS TO CURE SLAB.

11. STOREFRONT FRAMING TO BE RECESSED IN SLAB 1/2". SEE DETAIL SHEETS.

10. FLY-ASH PROHIBITED IN CONCRETE SLAB MIX.

EXTERIOR WINDOW (SEE ELEVATIONS)

AND FIRE DEPT. EE "E" DRAWINGS FOR

OF PRIMARY POWER LOSS.

LOCATION. SIGN SHALL BE CONTINUOUSLY ILLUMINATED FOR DURATION OF 90 MIN. IN CASE


ILLUMINATED EMERGENCY EXIT SIGN PER CBC


21. REFER TO CIVIL DRAWINGS FOR ALL POINT OF CONNECTIONS FOR UTILITIES. CONTRACTOR TO 22. PROVIDE STEEL BOLLARDS FILLED WITH CONCRETE AND PAINTED PER FINISH SCHEDULE AT FIRE RISERS, PIVS, TRANSFORMERS, AND OTHER LOCATIONS AS REQUIRED. SEE 10/AD.1.

Date: 5/17/2023 cale: As indicated HEET NUMBER

FLOOR PLAN

LEVEL 4

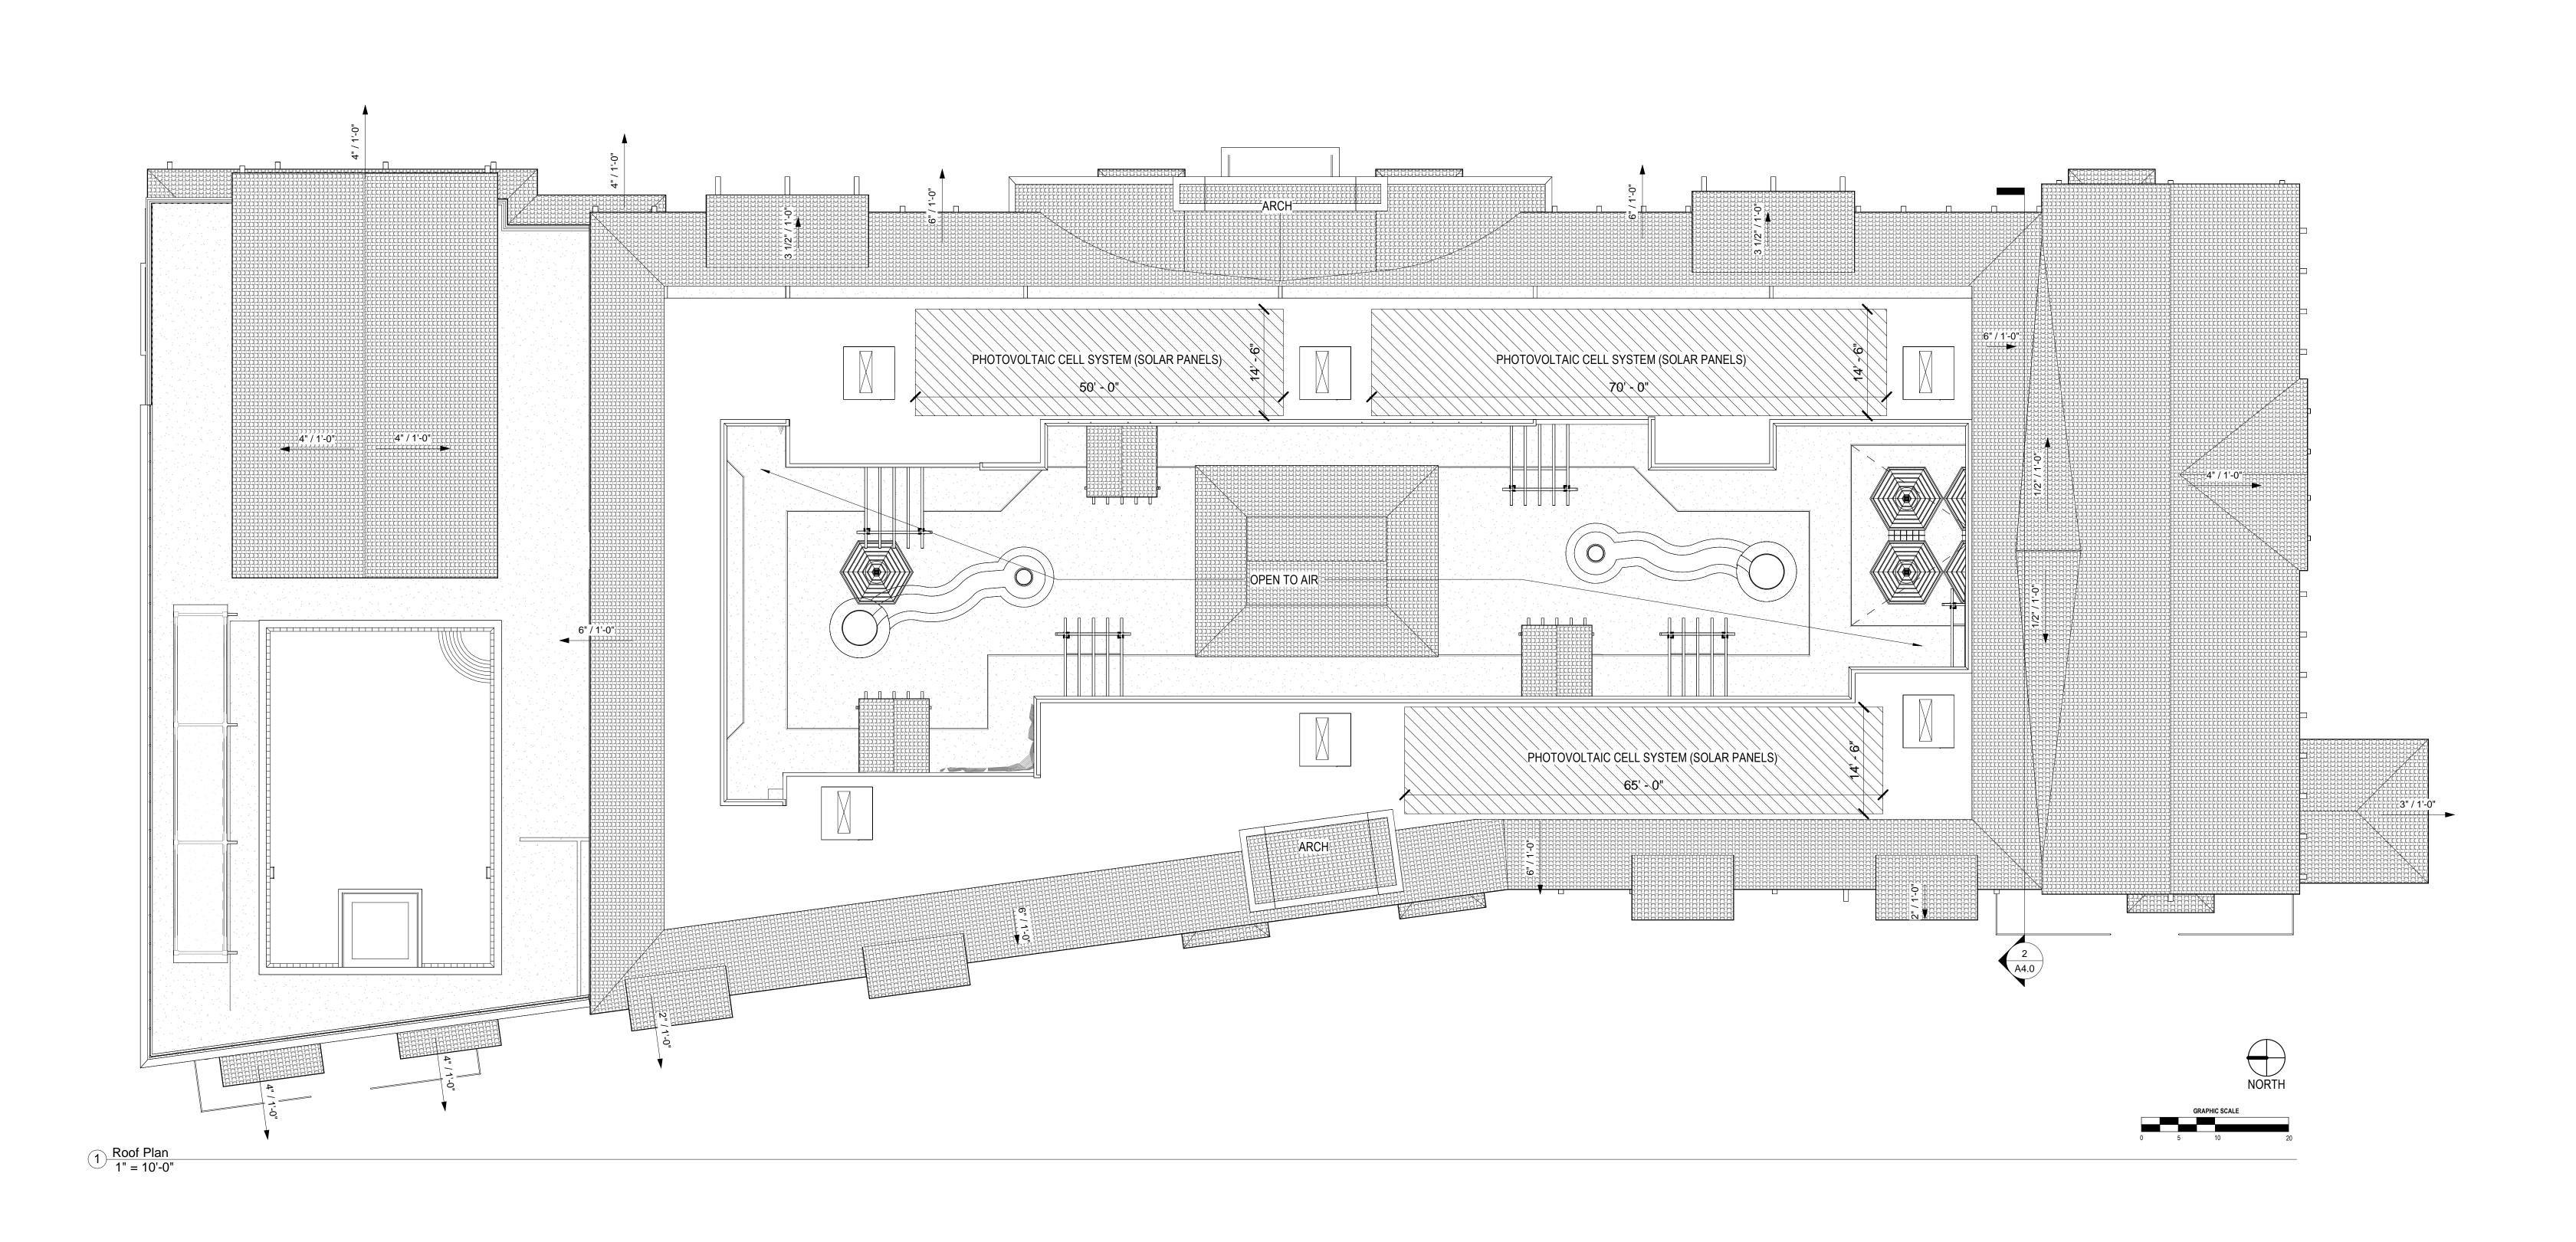

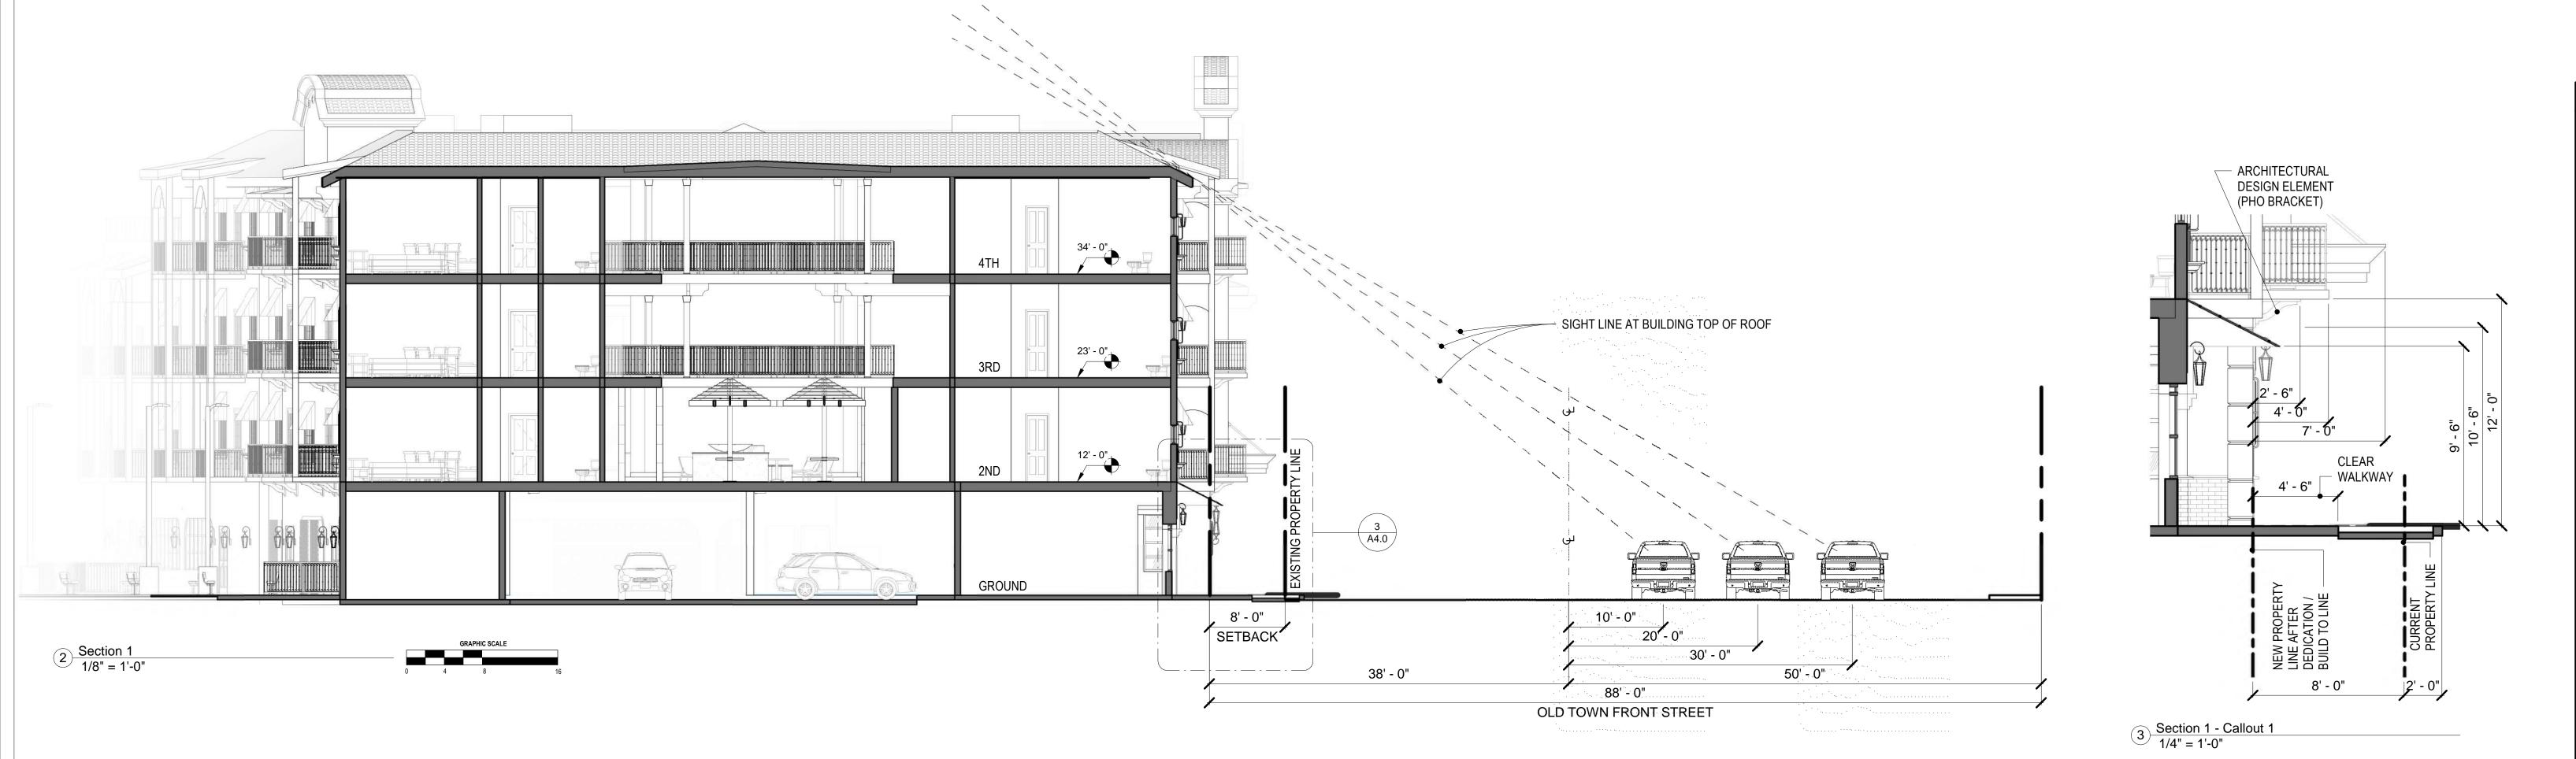

ROOF PLAN GENERAL NOTES

- 1. CONTRACTOR TO VERIFY POSITIVE ROOF DRAINAGE. ROOFING CONTRACTOR TO VERIFY PRIOR TO INSTALLING RIGID INSULATION OR ROOFING. SEE "S" DRAWINGS FOR CRICKETS, ETC.
- 2. BUILT UP ROOFING TO BE CLASS 1 UL LISTED ROOFING ASSEMBLY DESIGNED TO RESIST 90MPH OR AS REQUIRED.
- 3. SEE STRUCTURAL DRAWINGS FOR ROOF ELEVATIONS, TYP.
- 4. REFER TO DETAIL 1/AD.1 FOR TYPICAL ROOF SECTION.
- PROVIDE CRICKETS ON (HIGH SIDE) OF ALL MECHANICAL UNITS AND ROOF EQUIPMENT AT SKYLIGHTS & SMOKE HATCHES. PROVIDE POSITIVE DRAINAGE AROUND UNITS AT 1/2" PER SLOPE
- 6. CONTRACTOR TO COORDINATE ALL ROOF PENETRATIONS. SEE ROOF DETAIL SHEET FOR
- ALL SKYLIGHTS AND SMOKESTACKS TO BE DESIGNED TO MEET WINDLOAD AS DETERMINED BY
- THE BUILDING CODE AND LOCAL JURISDICTION.
- 8. ALL MECHANICAL CONDENSATE DRAINS TO BE BELOW ROOF.

9. G.C. TO CONFIRM REQUIREMENT FOR ROOF WALK PADS WITH OWNER.

- 10. ROOFING CAP SHEET TO HAVE MINIMUM AGED SOLAR REFLECTANCE EQUAL TO OR GREATER THAN 0.63, AND AN SRI EQUAL TO OR GREATER THAN 72 PER 2014 COUNTY OF LOS ANGELES GREEN
- BUILDING STANDARDS CODE
- 11. ROOF ELEVATIONS TO BE VERIFIED WITHTABLE A5.106.11.2.2 STRUCTURAL DRAWINGS.
- 12. FOR ALL PIPE AND DUCT PENETRATIONS THRU ROOF, SEE DETAILS ON AD SHEETS
- 13. ALL CONDENSATE LINES FROM HVAC UNITS MUST BE INSTALLED BELOW ROOF
- 14. ALL MECHANICAL EQUIPMENT WEIGHTS ARE OPERATING WEIGHTS.
- 15. PROVIDE A FULL TIME OSB MOISTURE INSPECTION AND GAP DISTANCE, BY A QUALIFIED ROOFING INSPECTION FIRM APPROVED BY THE OWNER AND THE OSB MANUFACTURER.
- INSPECTION FIRM TO BE ON SITE PRIOR TO THE START OF ANY BUILT UP ROOFING WORK. 16. ALL WOOD CURBS TO BE P.T.D.F.
- 17. ROOF EXHAUST FANS SHALL BE CENTERED DIRECTLY ABOVE A SPRINKLER HEAD. VERIFY WITH FIRE PROTECTION PLANS PRIOR TO INSTALLATION.
- 18. ALL SUB-PURLIN HANGERS HALL BE "Z-MAX" TRIPLE ZINC COATED AS MANUF. BY SIMPSON OR APPROVED EQUAL. 19. AUTOMATIC SPRINKLER SYSTEMS SERVING MORE THAN 100 SPRINKLER HEADS SHALL BE SUPERVISED BY AN APPROVED CENTRAL PROPRIETARY, OR REMOTE STATION SERVICE, OR A LOCAL ALARM WHICH WILL GIVE AN AUDIBLE SIGNAL AT CONSTANTLY ATTENDED LOCATION.

OM DEVELOPMENT AND CONSTRUCTION Consultant:

Walter R. Allen

Architect + Associates

License Number: C24288

PA22-0929, PA22-0930, PA22-0931

SUBMITTAL #5


APN: 922-100-048 OCK NUMBER: M.B. 15/726 LOT #2 BLOCK 32 **ROOF PLAN**

te: 5/17/2023 Scale: As indicated SHEET NUMBER


A4.0





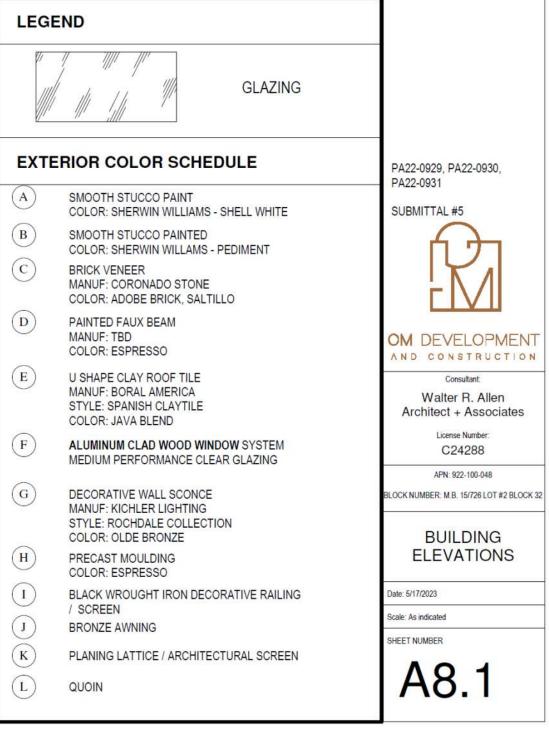

NOTE: VARIED / ASYMMETRIC ROOF AND BUILDING DESIGN IS HEAVILY COMMON IN BOTH ANDALUSIAN STYLE AND MISSION REVIVAL

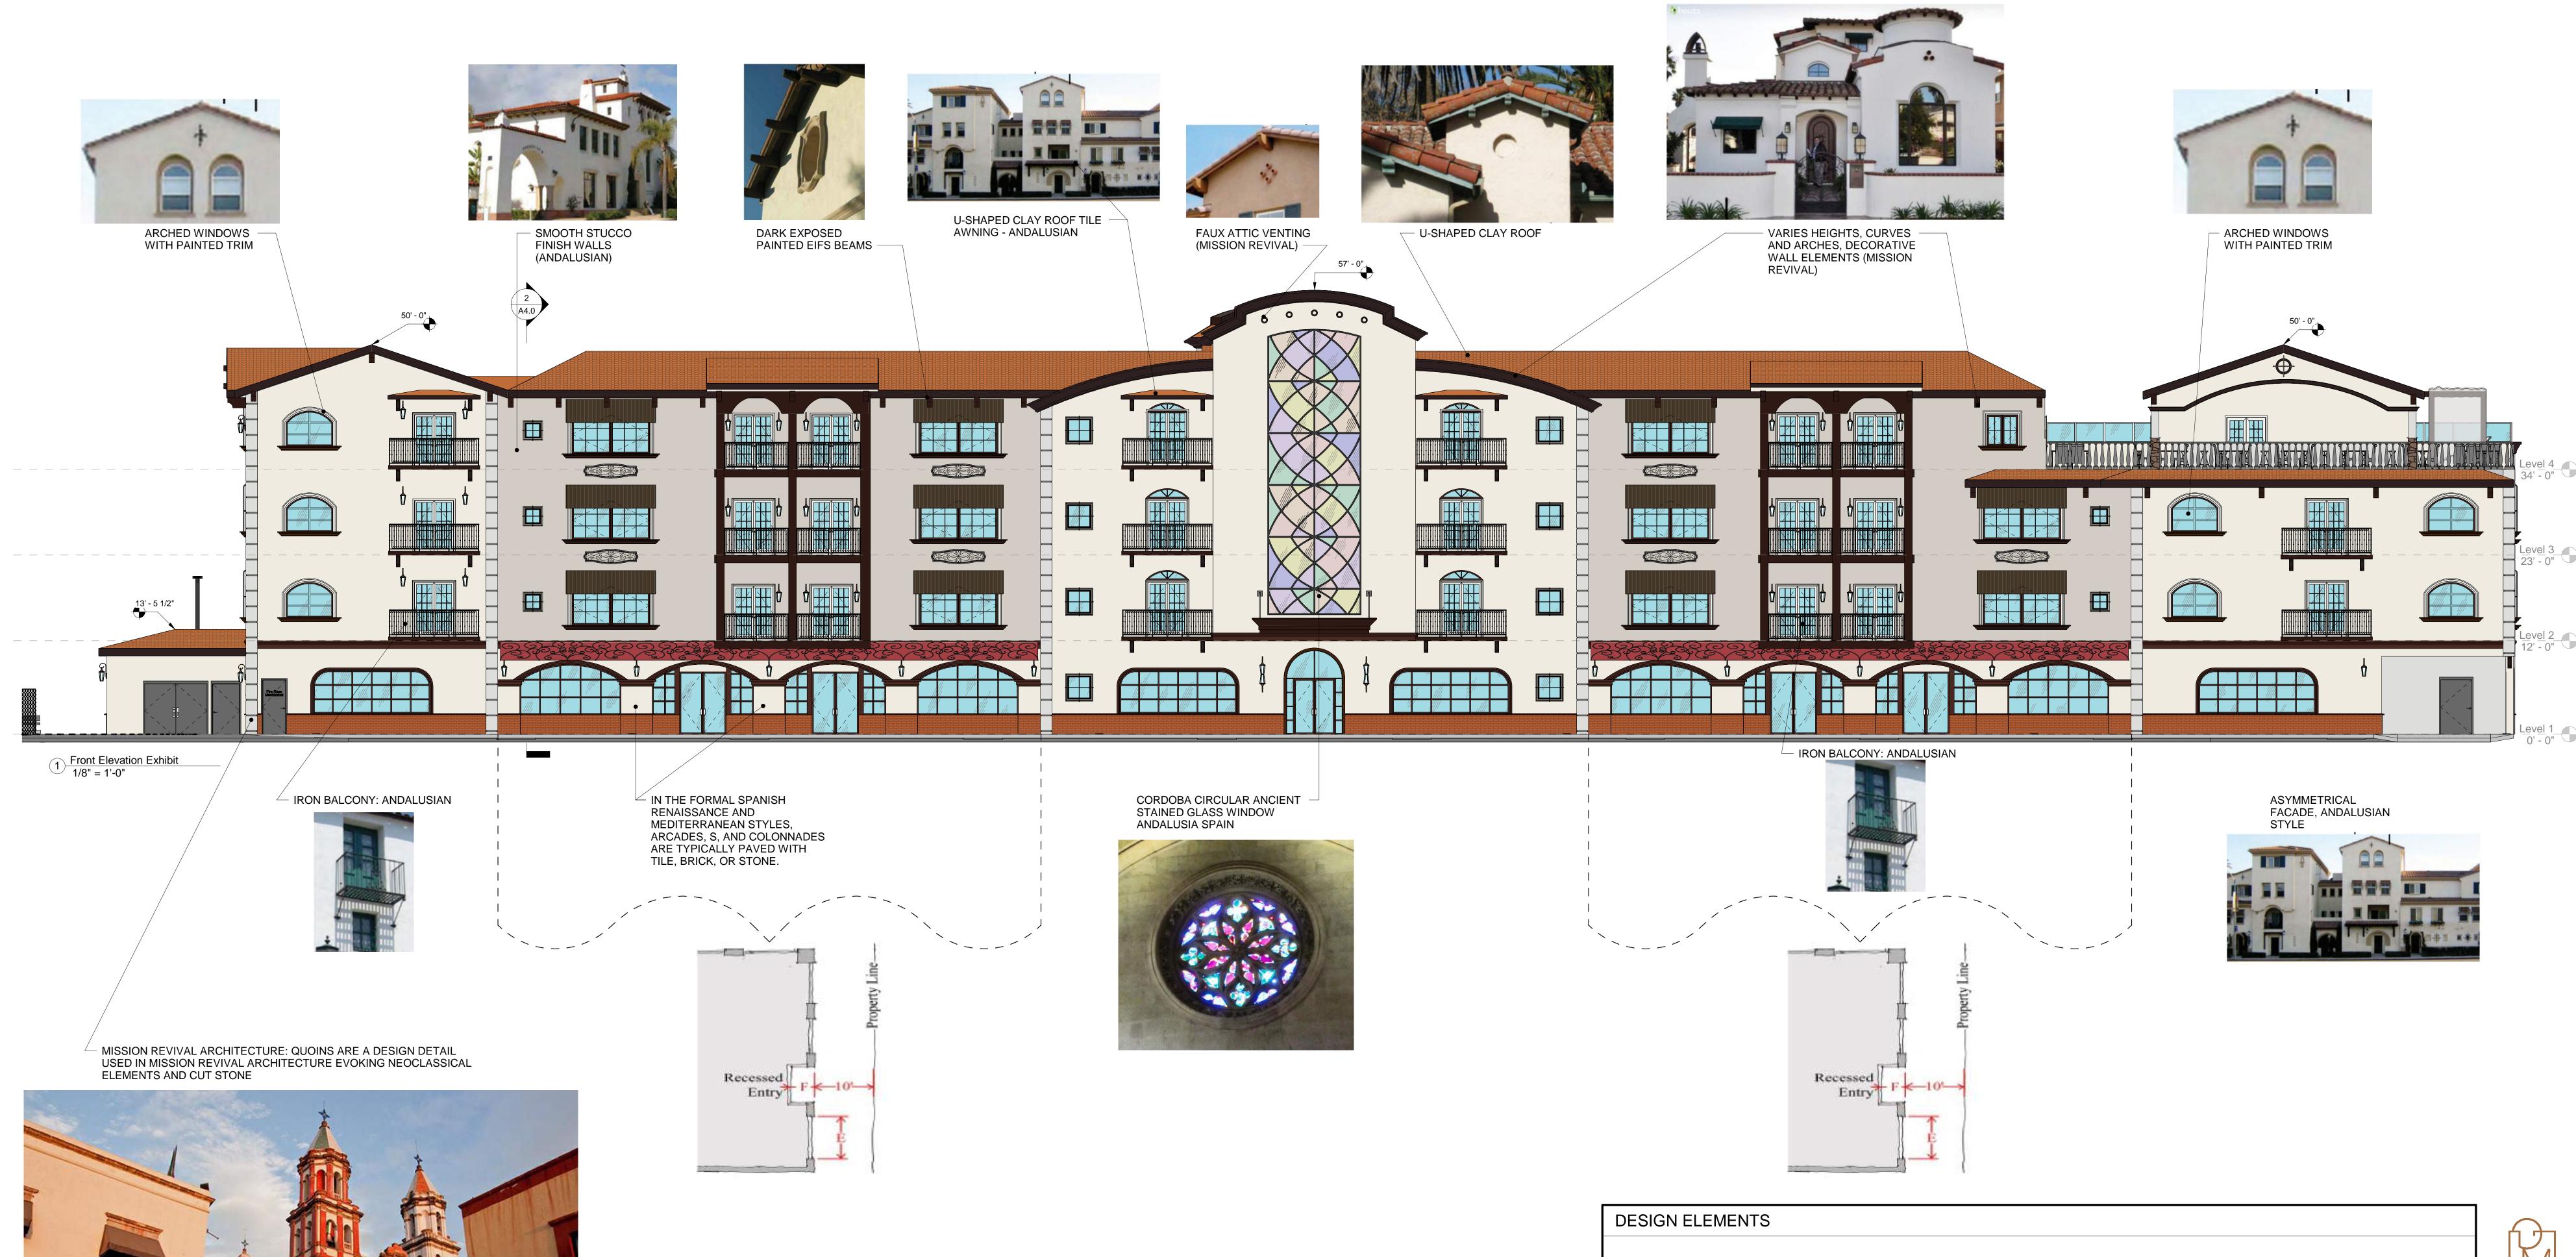

- V-21 SHOPFRONT FRONTAGES MAY BE USED FOR GROUND FLOOR COMMERCIAL USES AND MAY INCLUDE ENTRANCES TO RESIDENTIAL UNITS ON UPPER FLOORS. THE BUILDING FACADE IS ALIGNED WITH THE BUILD-TO LINE, WHICH IS 10 FEET BACK FROM THE PROPERTY LINE. RECESSED ENTRANCES ARE PERMITTED. BUILDING ENTRANCES ARE AT SIDEWALK GRADE. SHOPFRONT ELEMENTS INCLUDE DISPLAY WINDOWS, ENTRANCES, AWNINGS, CANOPIES, SIGNAGE, LIGHTING, CORNICES, AND OTHER ARCHITECTURAL ELEMENTS. A SOLID BASE OR BULKHEAD MUST BE PROVIDED BELOW THE DISPLAY WINDOWS. A CORNICE OR HORIZONTAL BAND MUST BE PROVIDED ABOVE THE DISPLAY WINDOWS TO DIFFERENTIATE THE SHOPFRONT FROM THE UPPER LEVELS OF THE BUILDING
- V-32 SPANISH INFLUENCE INCLUDES MISSION REVIVAL, SPANISH RENAISSANCE, AND ANDALUSIAN. THEY SHARE ELEMENTS SUCH AS TILE ROOFS. SMOOTH STUCCO EXTERIOR WALLS AND IRON BALCONIES. THEY REPRESENT DIFFERENT SPANISH ARCHITECTURAL TRADITIONS. IN PRACTICE, ELEMENTS OF THESE THREE STYLES ARE OFTEN BLENDED TOGETHER.

 ANDALUSIAN IS THE PRIMARY STYLE OF THE HOTEL. THE GROUND LEVEL IS A
- MIX OF GALLERY AND SHOPFRONT DESIGN.
- HEIGHTS.

V-33 FACADES ARE ASYMMETRICAL, AND BUILDING MASSING MAY CONSIST OF A MIX OF

- V-35 A SUMMARY OF THE GENERAL SPANISH INFLUENCED STYLE ELEMENTS COMMON TO ALL THREE SUB-STYLES INCLUDED:
 - SOLID, MASSIVE WALLS WITH SMOOTH STUCCO FINISHES;
 LARGER OPENINGS ON THE GROUND FLOOR, SMALLER WINDOWS ABOVE;
 - DOOR AND WINDOW OPENING RECESSED FROM THE FACADE;
 ARCADES OR GALLERIES WITH ROUND ARCHES, FLAT ARCHES, OR RECTANGULAR OPENINGS, SET ON COLUMNS OF WOOD OR STUCCO;
 - WHITE OR SOFT PASTEL EARTH TONE COLORS;CERAMIC TILE ACCENTS



Consultant:

Walter R. Allen

Architect + Associates

License Number:
C24288

APN: 922-100-048

DCK NUMBER: M.B. 15/726 LOT #2 BLOCK 32

DOWNTOWN
ARCHITECTURAL
STYLE

Date: 5/17/2023

Scale: 1/8" = 1'-0"

SHEET NUMBER

A8.2





2 3D View 2

PA22-0929, PA22-0930, PA22-0931 SUBMITTAL #5



Consultant:

Walter R. Allen
Architect + Associates

License Number:
C24288

APN: 922-100-048

BLOCK NUMBER: M.B. 15/726 LOT #2 BLOCK 32

3D VIEWS

Date: 5/17/2023

A9.0



Consultant: WAITER R. ALIEN ARCHITECT + ASSOCIATES

> C24288 APN: 922-100-048 BLOCK NUMBER: M.B. 15/726 LOT #2 BLOCK 32 ISOMETRIC VIEW

#1 Date: 5/17/2023

SHEET NUMBER



1 Iso View 2

PA22-0929, PA22-0930, PA22-0931

OM DEVELOPMENT

Consultant:

WALTER R. ALLEN
ARCHITECT + ASSOCIATES

License Number:

C24288

APN: 922-100-048

BLOCK NUMBER: M.B. 15/726 LOT #2 BLOCK 32

ISOMETRIC VIEW #2

Date: 5/17/2023

Scale:
SHEET NUMBER


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CITY OF TEMECULA, COUNTY OF RIVERSIDE, STATE OF CALIFORNIA

OLD TOWN FRONT STREET HOTEL


PORTION LOT 2, MB 15 / 726


CONCEPTUAL GRADING EXHIBIT PA22-0929

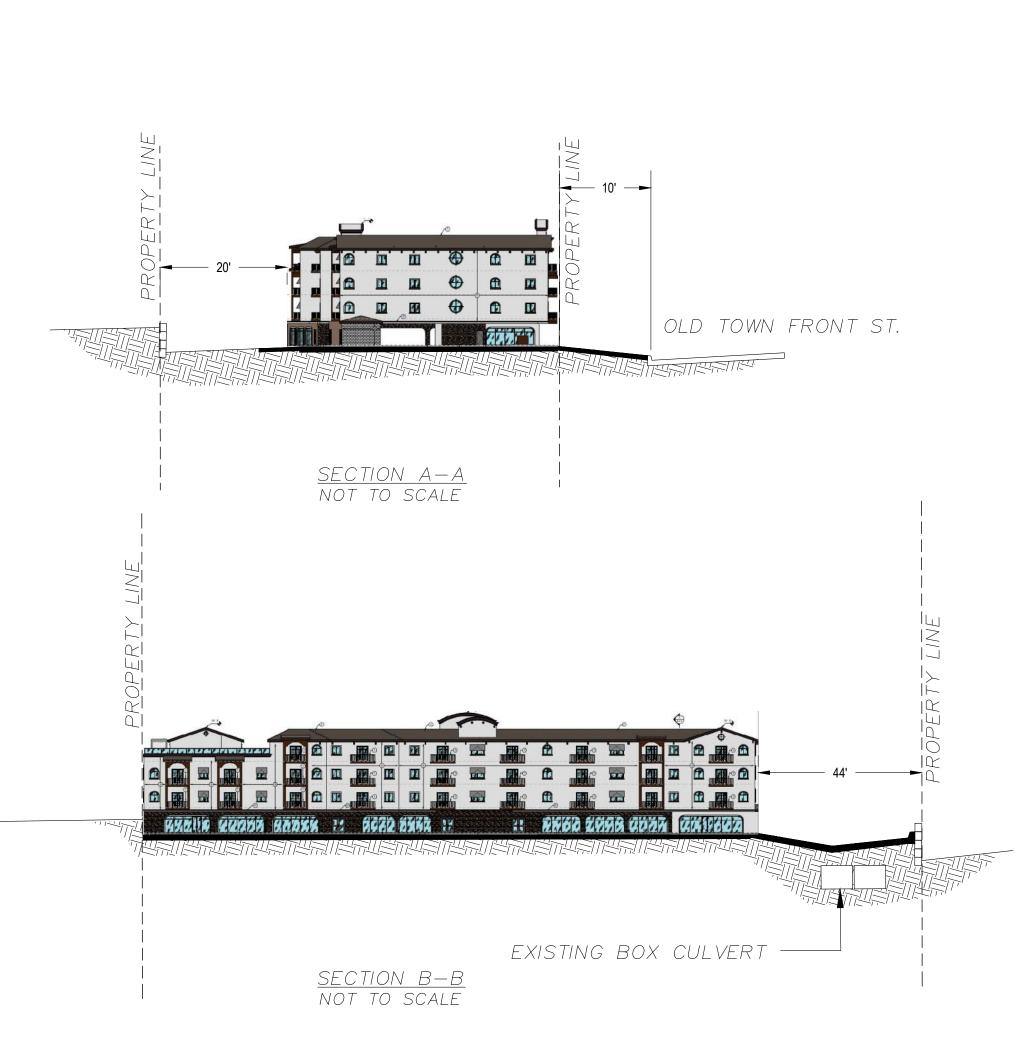

2010 THOMAS GUIDE PG 978, J-1

SEC 12, T8S, R3W

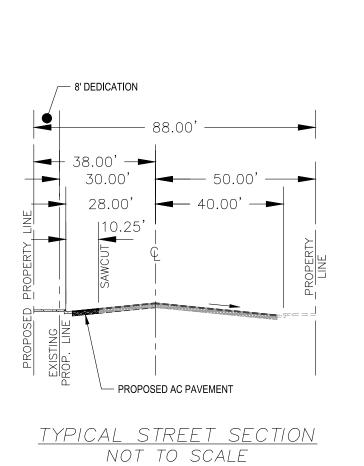

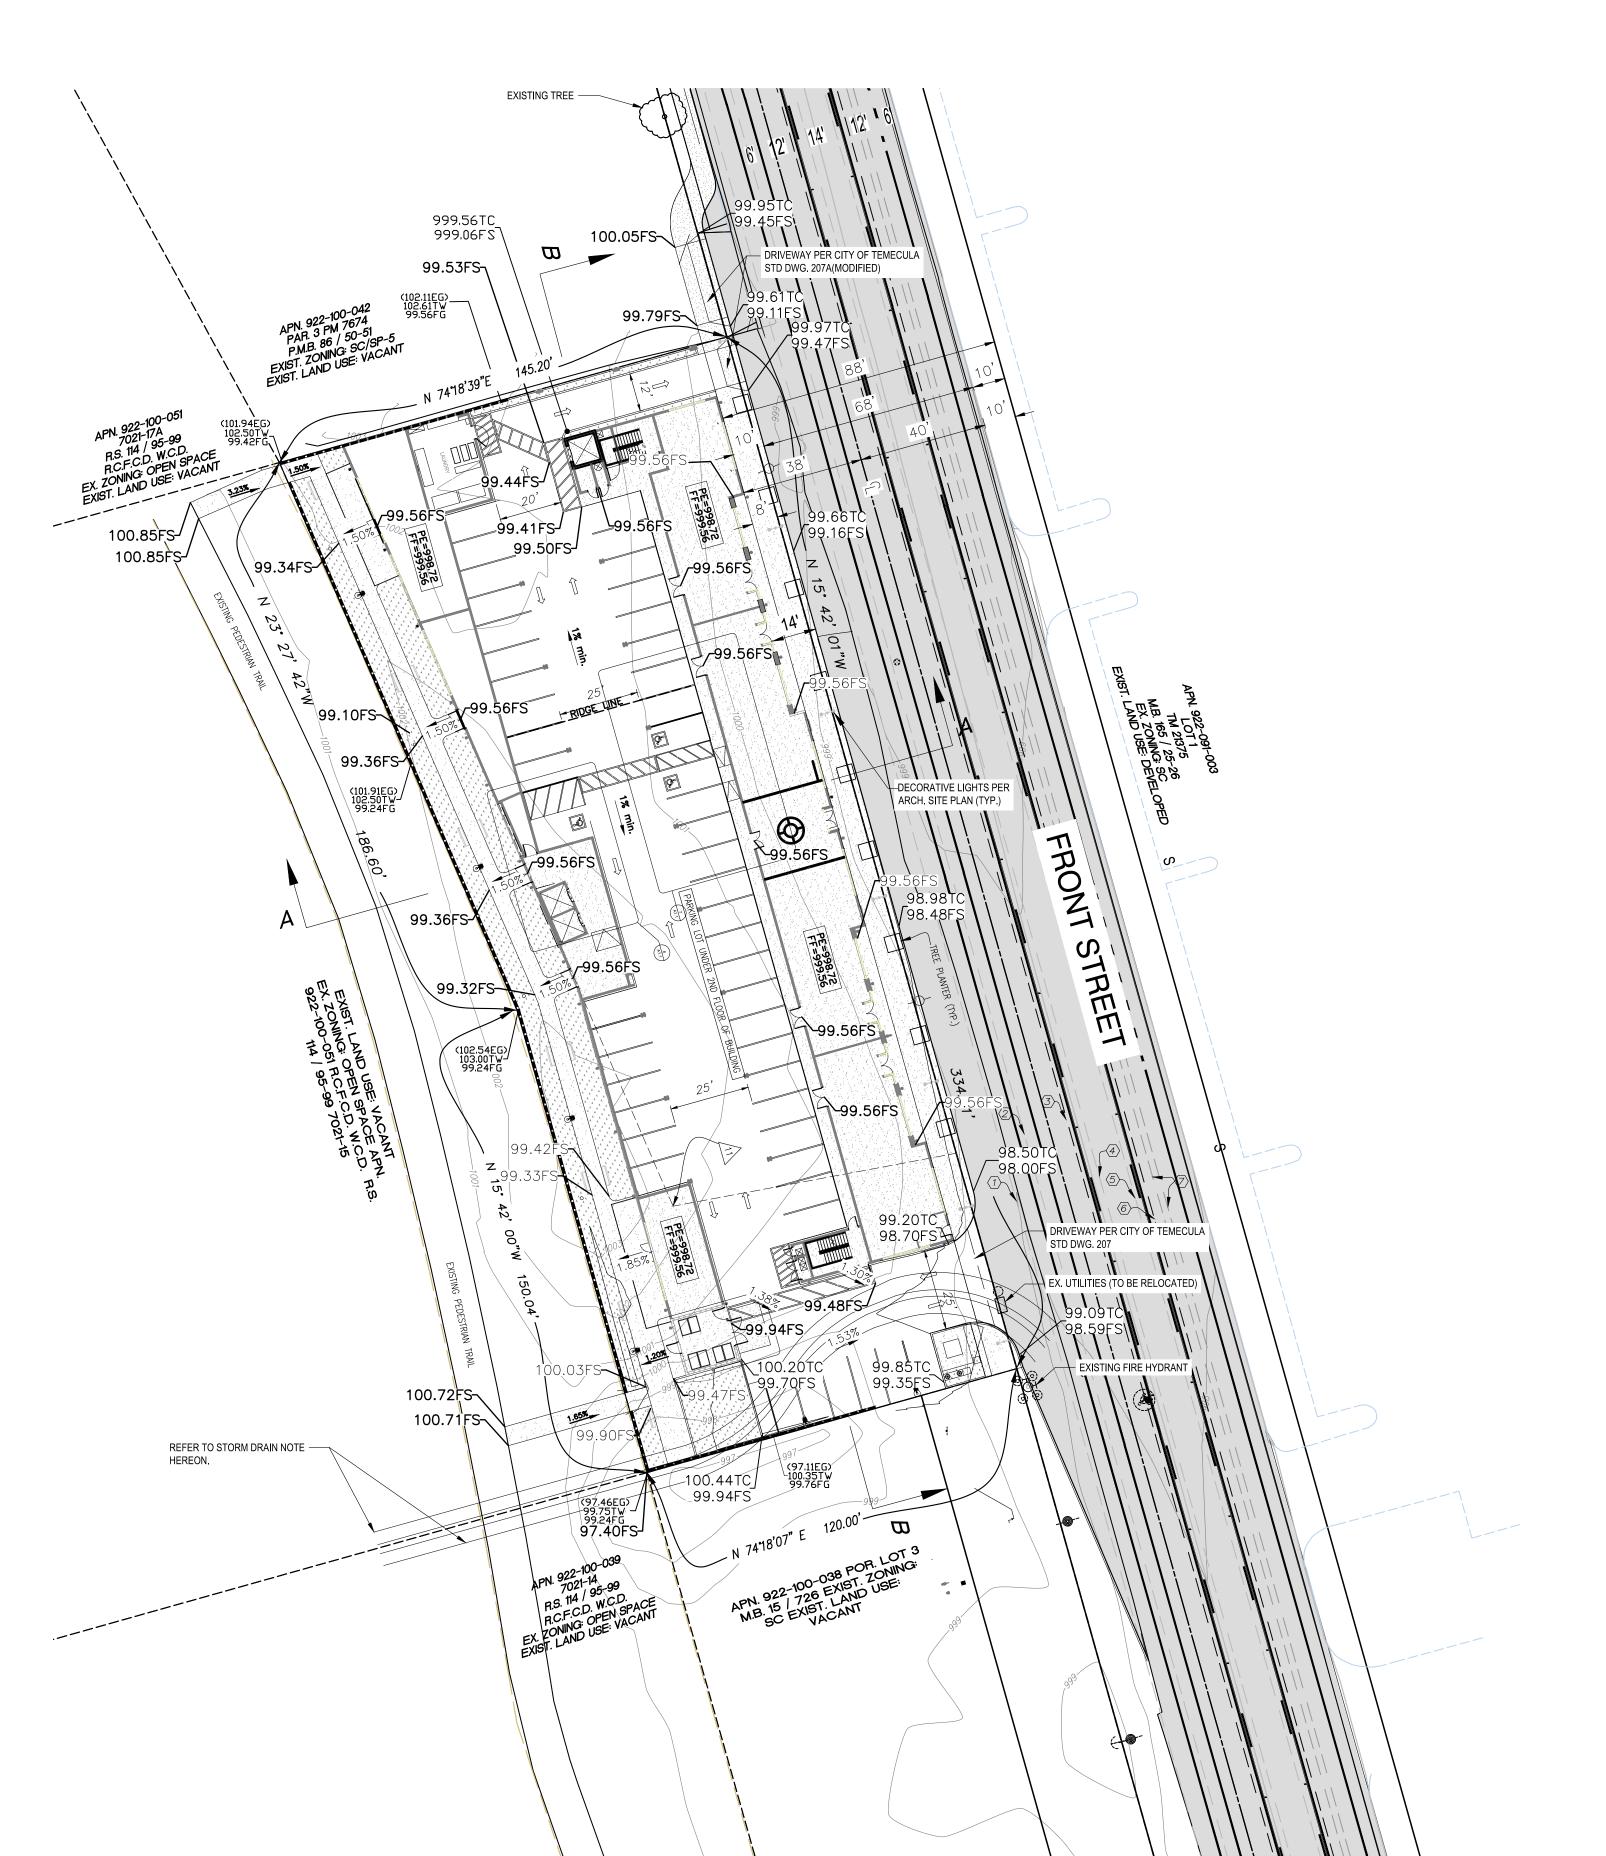

UTILITY PURVEYORS:

CABLE SPECTRUM COMMUNICATIONS 1250 N. KIRBY STREET HEMET, CA 92545 1-800-921-8101

> **ELECTRIC** SOUTHERN CALIFORNIA

26100 MENIFEE ROAD ROMOLAND, CA 92585

1-800-684-8123

SOUTHERN CALIFORNIA GAS COMPANY 1981 W. LUGONIA P.O. BOX 3003 REDLANDS, CA 92373 1-800-427-2200

EASTERN MUNICIPAL WATER

2270 TRUMBLE ROAD PERRIS, CA 92572 (951) 928-3777

TELEPHONE/INTERNET

COMMUNICATIONS 29310 BRADLEY

MENIFEE, CA. 92586 1-800-921-8101

RANCHO CALIFORNIA WATER DISTRICT 42135 WINCHESTER ROAD TEMECULA, CA 92592 (951) 296-6900

SCHOOL DISTRICT

TEMECULA UNIFIED SCHOOL 31350 RANCHO VISTA ROAD TEMECULA, CA 92592 (951) 676-2661

STORM DRAIN NOTE

ACTUAL LOCATION OF STORM DRAIN IS UNKNOWN. NO RECORD INFORMATION CAN BE FOUND THAT SUPPORTS ITS LOCATION HORIZONTALLY IN THE PROPERTY. PROPERTY OWNER TO POTHOLE FOR ACCURACY PRIOR TO OBTAINING GRADING PERMIT. HOLDER OF EASEMENT IS UNABLE TO BE DETERMINED. ALL STORM DRAIN TO BE VERIFIED IN FIELD BEFORE CONSTRUCTION.

UTILITY LEGEND

 $\langle 1 \rangle$ existing 8" water main

 $\langle 2 \rangle$ existing 20" water main

(3) EXISTING 8" SEWER MAIN

 $\langle 4 \rangle$ existing 20" reclaimed water main

(5) EXISTING 3" GAS MAIN

ARV

 $\langle 6 \rangle$ existing sewer forced main

 $\langle 7 \rangle$ existing underground telephone

ASSESSORS PARCEL NUMBER

air release valve

LEGEND

	ASPH	ASPHALT
\circ	В	BOLLARD
0-0	BFP	BACK FLOW PREVENTER
	CONC	CONCRETE
	DOC	DOCUMENT
000	EMH	ELECTRIC DRAIN MANHOLE
Ğ₁	FH	FIRE HYDRANT
\leftarrow	GUY	GUY ANCHOR
	O.R.	OFFICIAL RECORD
	R	PROPERTY LINE
	P.M.B.	PARCEL MAP BOOK
	PP	POWER POLE TO REMAIN AS IS.
¢		POWER POLE TO BE RE-ROUTED UNDERGROUND.
	SDI	STORM DRAIN INLET
0 0	SDMH	STORM DRAIN MANHOLE
· •	SMH	SEWER MANHOLE
	SQ FT	SQUARE FEET
0	SCO	SEWER CLEAN OUT
	TELE RSR	TELEPHONE RISER
	TELE VLT	TELEPHONE VAULT
	TRSFMR	TRANSFORMER
	WM	WATER METER

LEGAL DESCRIPTION

THE LAND REFERRED TO HEREIN IS SITUATED IN THE STATE OF CALIFORNIA, COUNTY OF RIVERSIDE, CITY OF TEMECULA AND IS DESCRIBED AS FOLLOWS:

LOT 2 IN BLOCK 32 OF THE TOWN OF TEMECULA, AS SHOWN BY MAP ON FILE IN BOOK 15 PAGE 726, OF MAPS, RECORDS OF SAN DIEGO COUNTY, CALIFORNIA;

EXCEPTING THEREFROM THAT PORTION CONVEYED TO RIVERSIDE COUNTY FLOOD CONTROL AND WATER CONSERVATION DISTRICT BY A FINAL ORDER OF CONDEMNATION RECORDED APRIL 3, 2009 AS INSTRUMENT NO. 09-163110 AND JULY 29, 2010 AS INSTRUMENT NO. 10-355371, BOTH OF OFFICIAL RECORDS.

BASIS OF BEARINGS

THE BEARINGS SHOWN HEREON ARE BASED ON RECORD OF SURVEY, R.S. 114/95-99, THE EAST LINE OF PARCEL 7021-15 IN THE OFFICE OF THE COUNTY RECORDER OF SAID COUNTY OF RIVERSIDE. RECORD BEARING BEING NORTH 23° 27' 42" WEST.

BENCHMARK

J-63 SECTION 1, T8S, R3W, S.B.M.-AT TEMECULA, RIVERSIDE COUNTY, ON MAIN ST., AT A RESTAURANT BUILDING AND THE FORMER FIRST NATIONAL BANK IN THE NORTHEAST CONCRETE WALL A STANDARD DISK STAMPED "J-63 1927" AND SET VERTICALLY. ADJUSTED ELEVATION 1005.651. ADJUSTED 1970 RIVERSIDE COUNTY

FLOOD INFORMATION

BY GRAPHIC PLOTTING ONLY, THIS PROPERTY IS IN ZONE(S) "AE" OF THE FLOOD INSURANCE RATE MAP COMMUNITY PANEL NO. 06065C3285G, WHICH BEARS AN EFFECTIVE DATE OF 08/28/2008 AND IS IN A SPECIAL FLOOD HAZARD AREA. SPECIAL FLOOD HAZARD AREAS ARE DEFINED AS THE AREA THAT

WILL BE INUNDATED BY FLOOD EVENT HAVING A 1-PERCENT CHANCE OF BEING EQUALED OR EXCEEDED IN ANY GIVIN YEAR. THE 1-PERCENT ANNUAL CHANCE FLOOD IS ALSO REFERRED TO AS THE BASE FLOOD OR 100-YEAR FLOOD.

STATEMENT OF UTILITIES

THE LOCATION OF UTILITIES SHOWN HEREON ARE FROM OBSERVED EVIDENCE AND PLANS PROVIDED BY THE CLIENT PURSUANT TO SECTION 5.E.iv. WHILE THE INFORMATION IS ASSUMED TO BE ACCURATE NO GUARANTEE IS MADE TO THE EXACT LOCATION OF THE UNDERGROUND

DATA TABLE

1.) ASSESSOR'S PARCEL NO.: 922-100-048

NO. 10-355371, BOTH OF OFFICIAL RECORDS.

2.) PROJECT NAME: OLD TOWN FRONT STREET HOTEL

3.) LEGAL DESCRIPTION: LOT 2 IN BLOCK 32 OF THE TOWN OF TEMECULA, AS SHOWN BY MAP ON FILE IN BOOK 15 PAGE 726, OF MAPS, RECORDS OF SAN DIEGO COUNTY, CALIFORNIA;

EXCEPTING THEREFROM THAT PORTION CONVEYED TO RIVERSIDE COUNTY FLOOD CONTROL AND WATER CONSERVATION DISTRICT BY A FINAL ORDER OF CONDEMNATION RECORDED APRIL 3, 2009 AS INSTRUMENT NO. 09-163110 AND JULY 29, 2010 AS INSTRUMENT

4.) ZONING DESIGNATION: (DOWNTOWN CORE DISTRICT) GENERAL PLAN: SC (SERVICE COMMERCIAL) SPECIFIC PLAN AREA: SP-5

EXISTING LAND USE/PROPOSED LAND USE: VACANT / HOTEL 5.) SOURCE OF TOPOGRAPHY: SPIRO LAND SURVEYING DATED OCTOBER 09, 2018.

6.) THIS PROPERTY IS WITHIN FEMA MAP 06065C3285G, AND IS NOT WITHIN A FEMA FLOODPLAIN OR FLOODWAY.

7.) TOTAL GROSS AREA: 42,519 S.F. 0.97 ACRES TOTAL NET AREA: 42,519 S.F. 0.97 ACRES TOTAL BUILDING AREA:

8.) PARKING: 47 STANDARD SPACES *3 ADA SPACES*

9.) LANDSCAPING IS PROPOSED IN THE CITY RIGHT-OF-WAY. CITY RIGHT-OF-WAY LANDSCAPING WILL BE MAINTAINED BY THE PROPERTY OWNER.

10.) GROSS AND DISTURBED ACREAGE: 0.97 AC

EASEMENT NOTES:

/9ackslash Easement and rights incidental thereto for public utilities, public service uses, as set forth in a document recorded February 7, 1975, as Instrument No. 15887, of Official Records. NOT PLOTTABLE

11\ Easement and rights incidental thereto for temporary construction easement, as set forth in a document recorded April 3, 2009, as Instrument No. 2009—0163110 and July 29, 2010 as Instrument No. 2010-0355371, both of Official Records.(TO BE VACATED)

OWNER/APPLICANT OM RESIDENTIAL REAL ESTATE, LLC

C/O SAMIR MOHAN 11606 HARRINGTON STREET BAKERSFIELD, CA. 93311-9273 R039 TEL: (951)-693-0301 TEL: (661) 699-5194 EMAIL: sam.bakersfieldclubs@gmail.com

41635 ENTERPRISE CIRCLE NORTH TEMECULA, CA. 92590 TEL: (951) 296-3466 EMAIL: info@4med.net

ARCHITECT

28465 OLD TOWN FRONT STREET #20 TEMECULA, CA. 92590 EMAIL: CAC.RQTEX@GMAIL.COM

SPIRO LAND SURVEYING

WALT ALLEN ARCHITECTS


4M ENGINEERING & DEVELOPMENT, INC. 603 SEAGAZE DRIVE #113 OCEANSIDE, CA. 92054 TEL: (951) 334-3174 EMAIL: matt@spirolandsurveying.com

PA22-0929

MAP PREPARED: September 21, 2023

THIS MAP IS BASED ON RECORD DATA AND SHOULD NOT BE RELIED UPON FOR ACCURATE SURVEY INFORMATION. ALL MEASUREMENTS SHALL BE FIELD VERIFIED BY PERSONS AUTHORIZED TO PERFORM SUCH WORK. ANY DESIGN INFORMATION SHOWN ON THIS PLAN IS CONCEPTUAL IN NATURE AND SHALL NOT BE RELIED ON FOR CONSTRUCTION

PURPOSES.

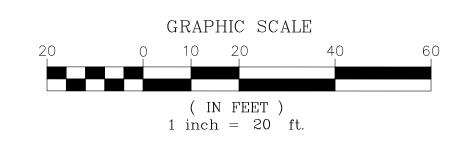




OWNER/APPLICANT	NO.	DATE	REVISION	ENGINEER:
OM RESIDENTIAL REAL ESTATE, LLC C/O SAMIR MOHAN 11606 HARRINGTON STREET BAKERSFIELD, CA. 93311-9273 R039				
TEL: (661) 699-5194 EMAIL: sam.bakersfieldclubs@gmail.com				

WATER VALVE FENCE - TYPICAL

41635 Enterprise Circle N. - Suite 8 Temecula, California 92590 TEL: (951) 296-3466 INFO@4MED.NET

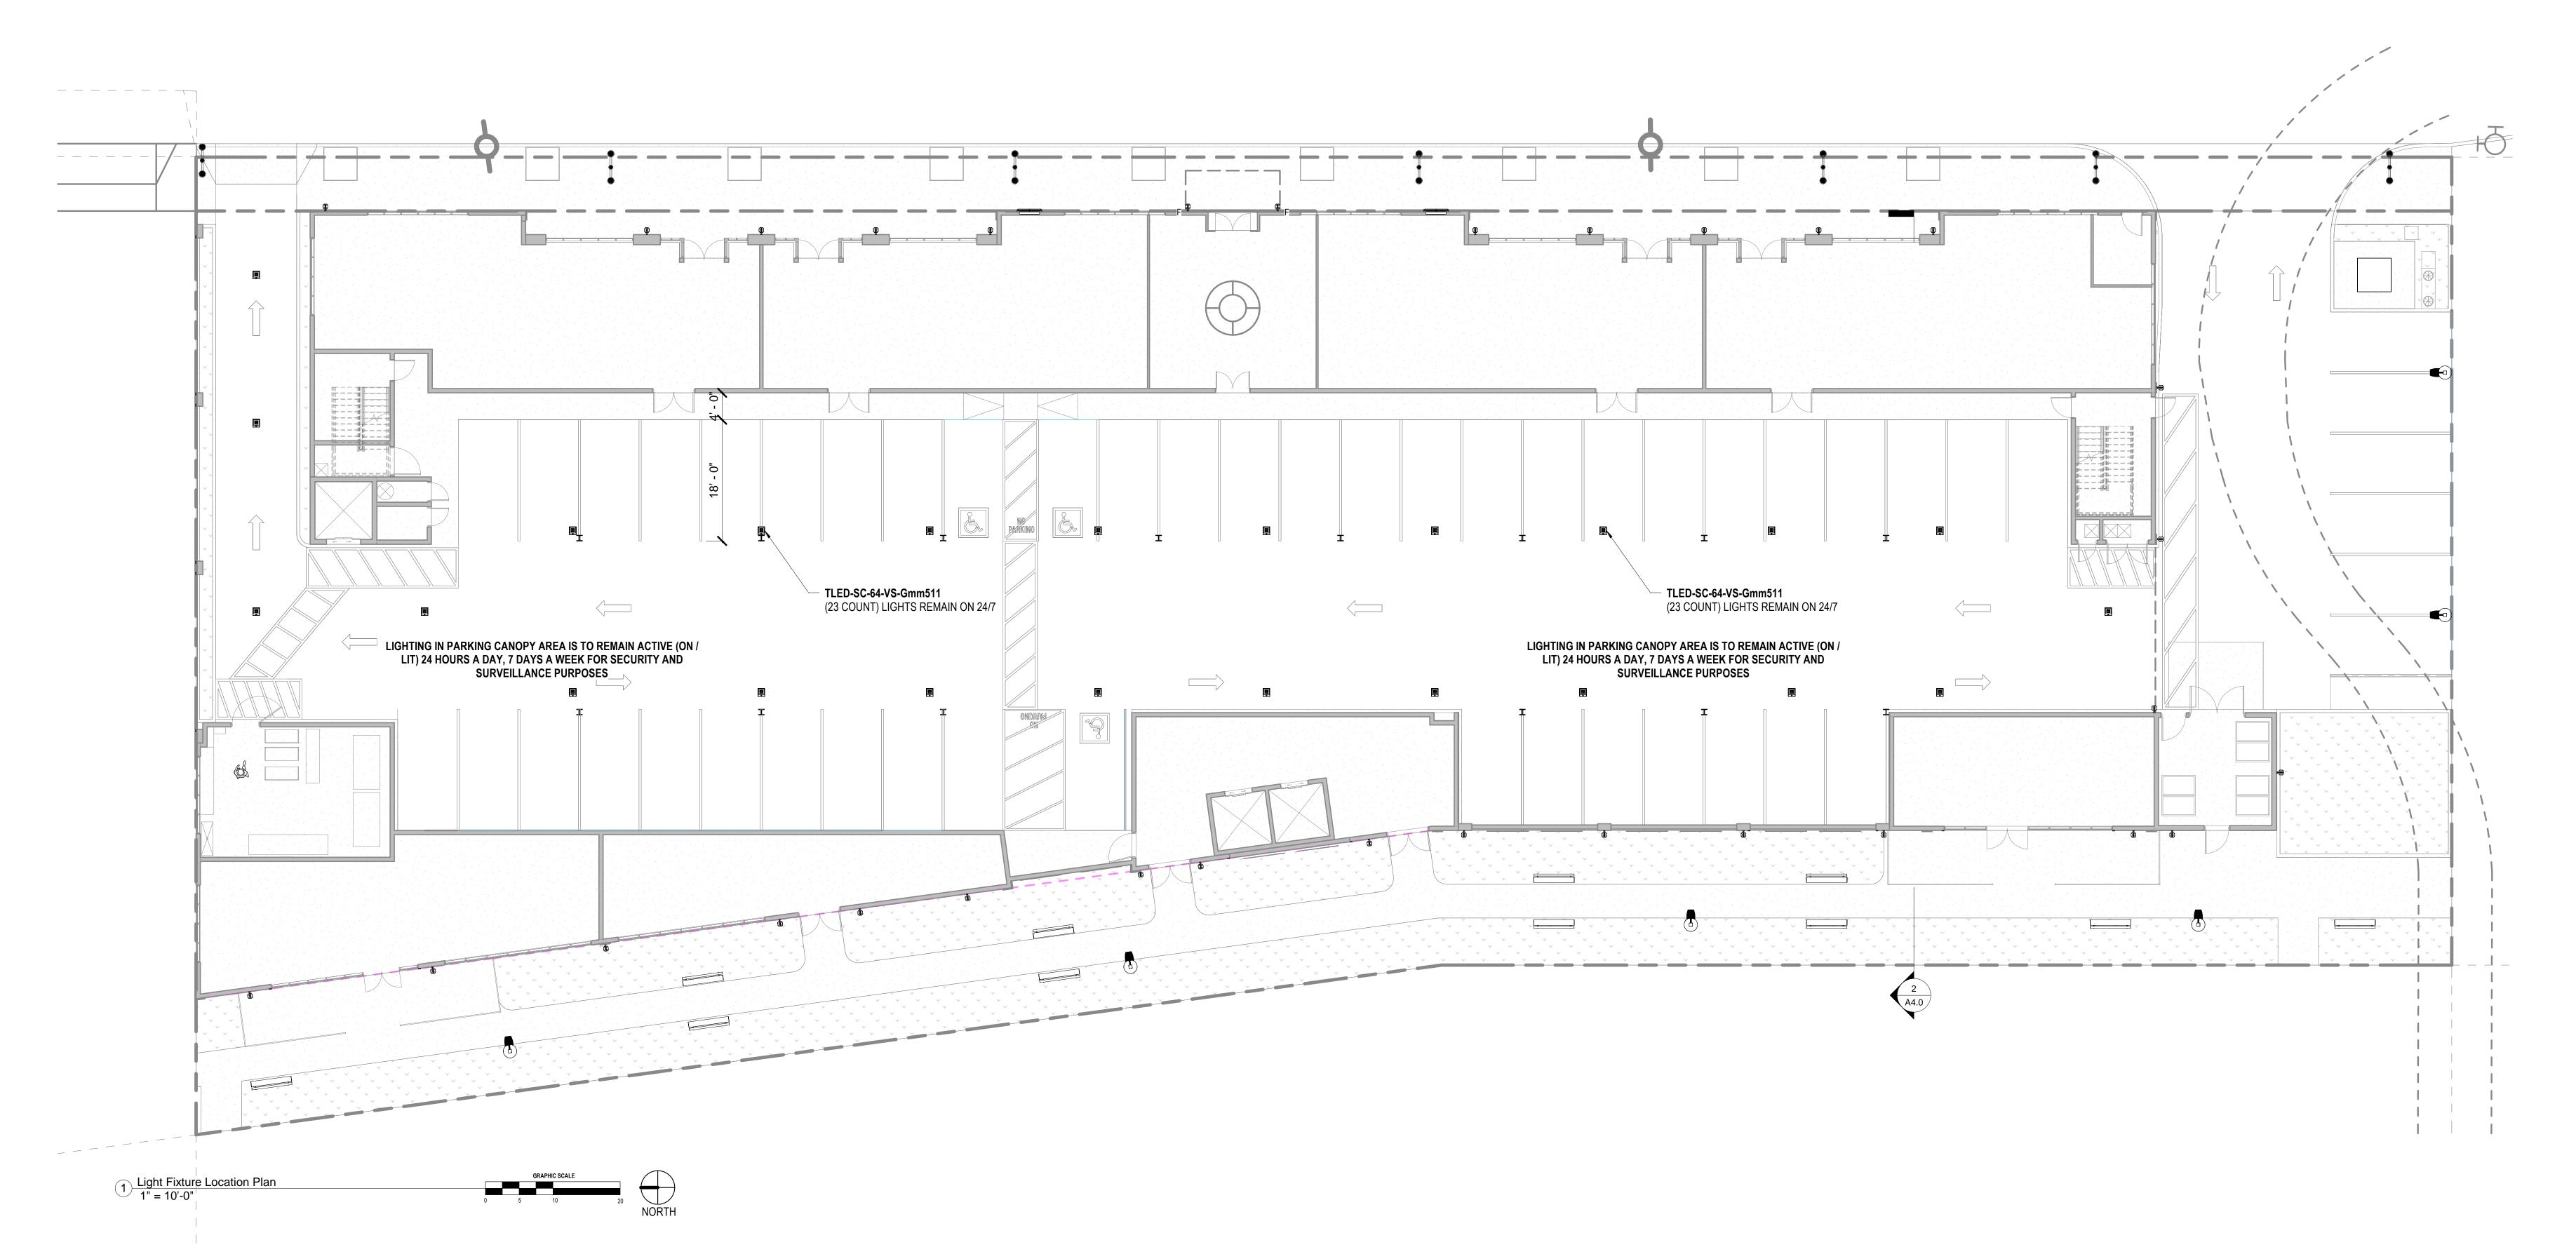

	LIGHT	NING	SCHE	DULE						
	SYMBOL	LABEL	QTY.	CATALOG NUMBER	DESCRIPTION	LAMP	NUMBER LAMPS	LUMENS PER LAMP	LLF	WATTAGE
		A	6 POLE 1 LAMP PER.	RZR-PLED- IV-40LED-350mA-40k-HS, 42.7W, 5055 lumens	4 CIRCUIT BOARDS EACH WITH 40 LEDS, 1 CLEAR PLASTIC OPTIC BELOW EACH LED, 1 FORMED SEMI-SPECULAR METAL OPTIC MOUNTING PLATE BELOW EACH CIRCUIT BOARD.		80	265	0.9	266.7
		В	32	KICHLER 49513OZ	WALL MOUNTED 24.75" HIGH LED FIXTURE 2700K.	(2) 4.5W LED CANDELABRA BASE	2	600	0.9	10
NOTE: TLED-SC-64-VS-Gmm511 WILL PROVIDE 24/7 LIGHTING FOR ADDED SECURITY AND SAFTEY OF THE GARAGE CANOPY SPACE	. 0	С	23	TLED-SC-64-VS-Gmm511	12"SQ. X 2-1/2"H. LED GARAGE CANOPY WITH INTEGRATED OCCUPANCY AND DAYLIGHT SENSOR LEDS WITH DINTED OPTICS		1	7724	0.9	75
		D	13							
					PER CITY OF TEMECULA	A: OLD TOWN SPECI	FIC PLAN SPECIFICAT	IONS		
	F	F	2	KICHLER 49514OZ	WALL MOUNTED 24.75" HIGH LED FIXTURE 2700K.	(6) 4.5W LED CANDELABRA BASE	6	1800	0.9	60

PA22-0929, PA22-0930, PA22-0931 SUBMITTAL #5



OM DEVELOPMENT

Consultant:

Walter R. Allen
Architect + Associates

License Number:
C24288

APN: 922-100-048

BLOCK NUMBER: M.B. 15/726 LOT #2 BLOCK 32


LIGHT FIXTURE LOCATION

Date: 5/17/2023

Scale: As indicated

SHEET NUMBER

ET NUMBER

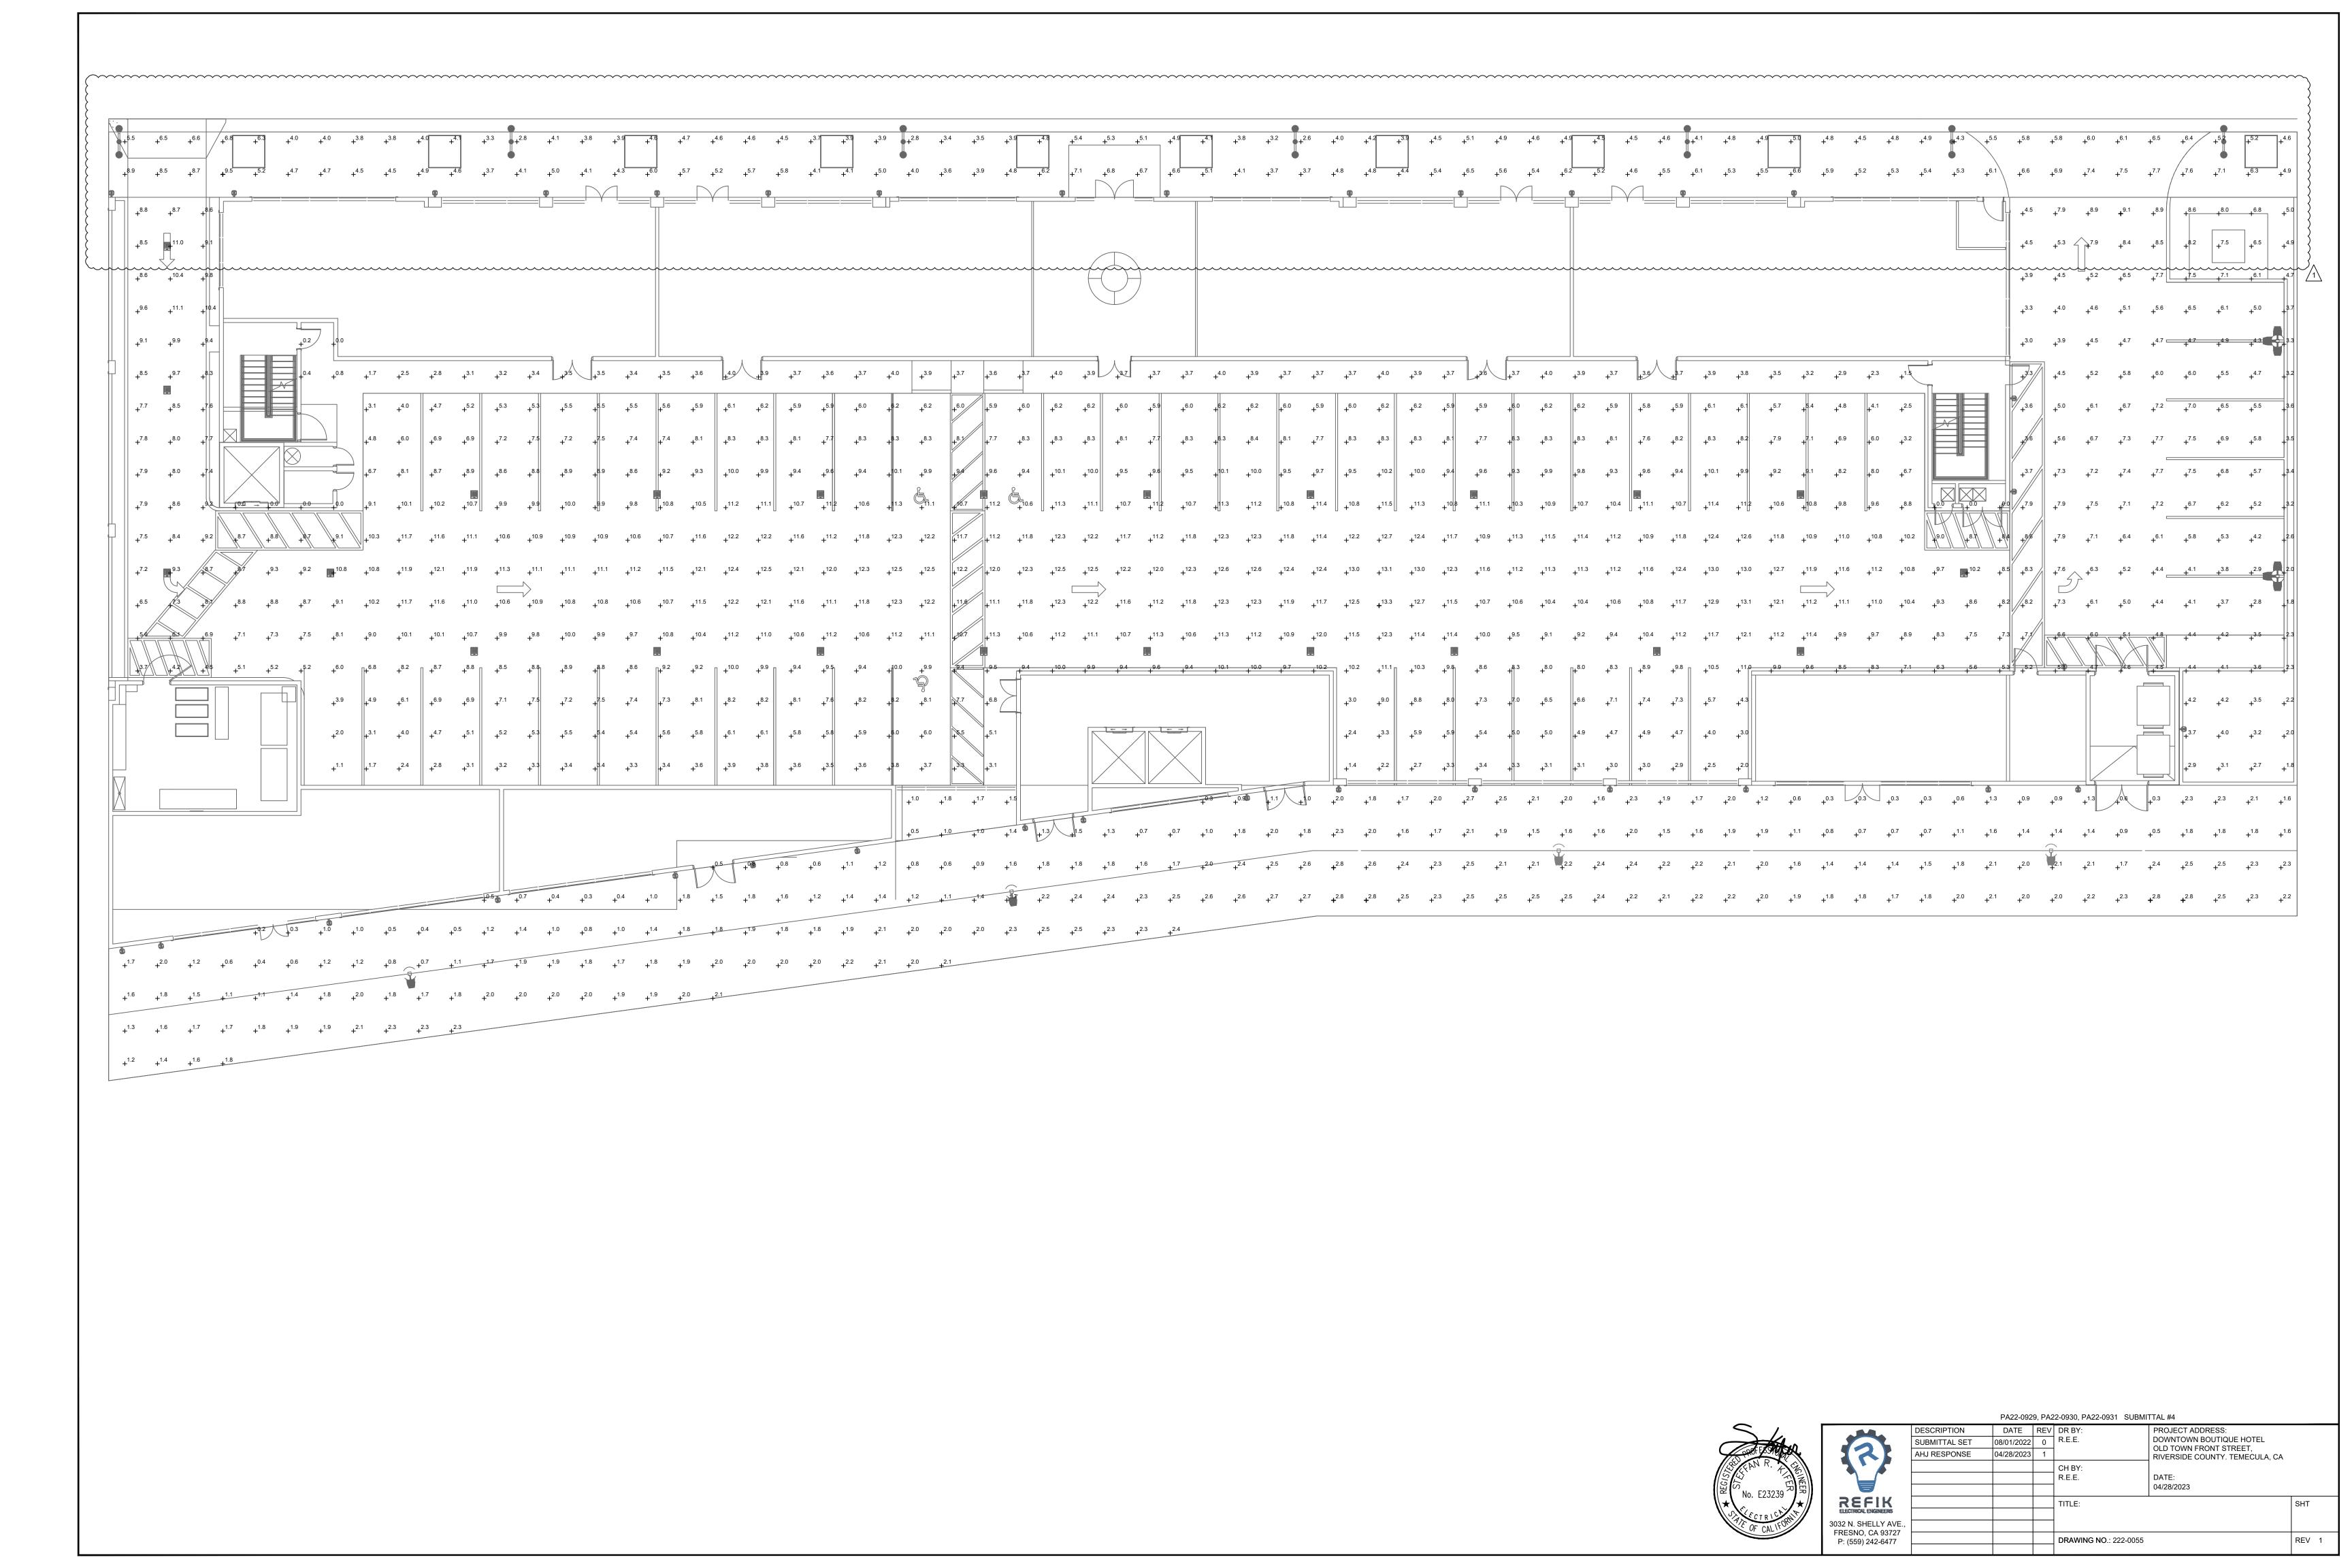

TRACE*LITE

DESCRIPTION

The TLED-SC sensor canopy utilizes TRACE*LITE's successful LED surface mount canopy design and brings it to a new level of performance and efficiency by the addition of the factory installed Wattstopper FSP-211 Digital High/Low passive infrared sensor. The sensor allows for fully adjustable high and low dimmed light levels based on motion, adjustable time delay, cut off delay and is controlled via the 0-10V dimming driver in the fixture. It also includes an integrated photocell to measure ambient light levels. This sensor is provided with an FSP-L2 lens that was selected for its proven design and ability to provide maximum coverage at an 8ft mounting height. Other lenses are available for multiple mounting heights. Contact factory for details. The TLED-SC series conforms to the Title 24 requirements in regards to dimming and control of light fixtures.

The TLED-SC extends the low profile form factor of the complete line by integrating the Wattstopper Occupancy and Daylight sensor on one side of the fixture, ensuring the ease of installation our LED canopy is known for. Our next generation high performance LED light engines feature our superior thermal management that make the entire family an attractive, energy saving choice. Constructed of die formed and welded aluminum, the TLED canopy series family has been engineered to deliver optimum optical performance and lamp longevity. The attractive and durable housings have a UV resistant, powder coated finish to protect against the elements and are ETL Listed for Wet Locations. Our TLED series canopies incorporate contractor friendly features that allow for ease of installation in a variety of applications and can be installed by a single person. The TLED-SC series canopies provide an energy saving solution to a wide spectrum of applications including, but not limited to security lighting in schools, office complexes, light commercial development, apartments, parking garages, entryways, and stairwells. The TLED series canopies are DesignLights Consortium™ (DLC) qualified and meet or exceed the efficacy requirements for various rebate programs across the country (consult DLC QPL website for listed models).

SPECIFICATIONS Construction:

Precision die formed aluminum housings feature clean architectural lines with ample, integral mounting space for future accessories. The TLED canopy series family's most important construction feature is their integral thermal management. The housing is fabricated using 1/8" aluminum plate, which not only provides strength and durability but also acts as a substantial heat sink and allows for optimum performance and durability of the LED light engine without sacrificing design aesthetics or increasing the outside dimensions of the housing. LEDLITE/logic heat sinking technology moves heat away from the LEDs by taking advantage of thermal convection dynamic properties and maximizing system performance that delivers up to a 190,000 hour life with 70% lumen maintenance. The TLED canopy series family is ETL Listed for Wet Locations, and incorporates a UV resistant, long lasting, polyester based powder coat finish.

The TLED canopy series family of luminaires deliver exceptional light quality and efficiency with a garage optic design that provides excellent Type VS distribution. Our garage optic provides more lumens in the 60° to 80° zone, which satisfies the DLC requirements for parking garage luminaires. The stabilized optical PMMA lenses are specifically designed to distribute light where it is needed in the most efficient way possible making it the ideal luminaire for high efficiency applications.

Electrical:

The available LED light engine wattages are powered by 0-10V dimmable, constant current control drivers and provide up to a 190,000 hour rated life with 70% lumen maintenance, at 4700K CCT, and a CRI of ≥72. All drivers are Class 2 power supplies with input voltage range of 120VAC to 277AVC, providing a Class A EMI rating and a high power factor of ≥0.90. The TLED series canopies are suitable for operation in -40°F to 104°F (-40°C to 40°C) ambient conditions.

to 104°F (-40°C to 40°C) ambient conditions.

Thermal Management:

LEDLITE logic heat sinking technology moves heat away from the LEDs by taking advantage of thermal convection dynamic properties and maximizing system performance that delivers up to a 190,000 hour life with 70% lumen maintenance.

Environmentally Friendly Design:

TLED-SC canopy series luminaires consume very little energy and provide long life

Hazardous Substances) compliant and provides a significant reduction in KW load and carbon emissions.

Installation:

The TLED series canopies can be installed and wired by a single person. The base plate easily attaches to a 3" or 4" J-box, and the fixture housing is attached to the base plate by four (4) captive fasteners. The TLED-SC can be surface mounted to a recessed

J-box or pendant mounted using a standard 1/2" downrod & hardware (supplied by

in comparison to traditional lamp technologies. The TLED-SC is RoHS (Restriction of

Transient Protection System (Option: TP):

The LEDLITE logic optional transient protection device is designed to be used in conjunction with our LED drivers. The "-TP" option utilizes a 3-leaded device that protects Line-Ground, Line-Neutral, and Neutral-Ground in accordance with IEEE/ANSI

C62.41.2 guidelines. The surge current rating of the "-TP" option is 10,000 amps.

TLED-SC Surface Mount LED Garage/Canopy Lighting with Integrated Occupancy and Daylight Sensor

Accessories:

Job Name:

Type:

AVAILABLE WHILE SUPPLIES LAST



Specs at a Glance			
	18 LED	36 LED	48 LED
Wattage (Nominal)	21W	41W	55W
Ingress Protection	UL Li	sted for Wet Loca	ations
Lumens (Im)	1907	4119	5712
Efficacy (LPW)	92	101	104
сст		4700K	
Input Voltage	120-	~277 Voltage Ser	nsing
Optics	Performan	ce Optic - Type V	Very Short
CRI		≥72	
Warranty		5 Years	
Ambient Temp	-40°F t	o 104°F (-40°C to	o 40°C)


Testing & Compliance:
The reliability and performance of the TLED canopy series luminaires are evaluated in accordance with the parameters outlined and reported by LM-79 and LM-80 documents. Photometric data is tested to IESNA LM-79-08 standard by an independent testing laboratory. Lumen maintenance, or L70, a measure of long term reliability, is determined for the light source, which consists of the LED and PSB sub-assembly as installed in the luminaire, using LM-80 in-situ thermal and reliability data as provided by the LED manufacturer in accordance with DOE/EPA standards. DesignLights Consortium® (DLC) qualified luminaire (check QPL


Listing:
The TLED-SC is ETL certified under UL1598 specifications and listed for wet locations.

Warranty:


Warranty:


Any component that fails due to manufacturer's defect is guaranteed for 5 years. The warranty does not cover physical damage, abuse or acts of God. Manufacturer reserves the right to charge for such repairs if deemed

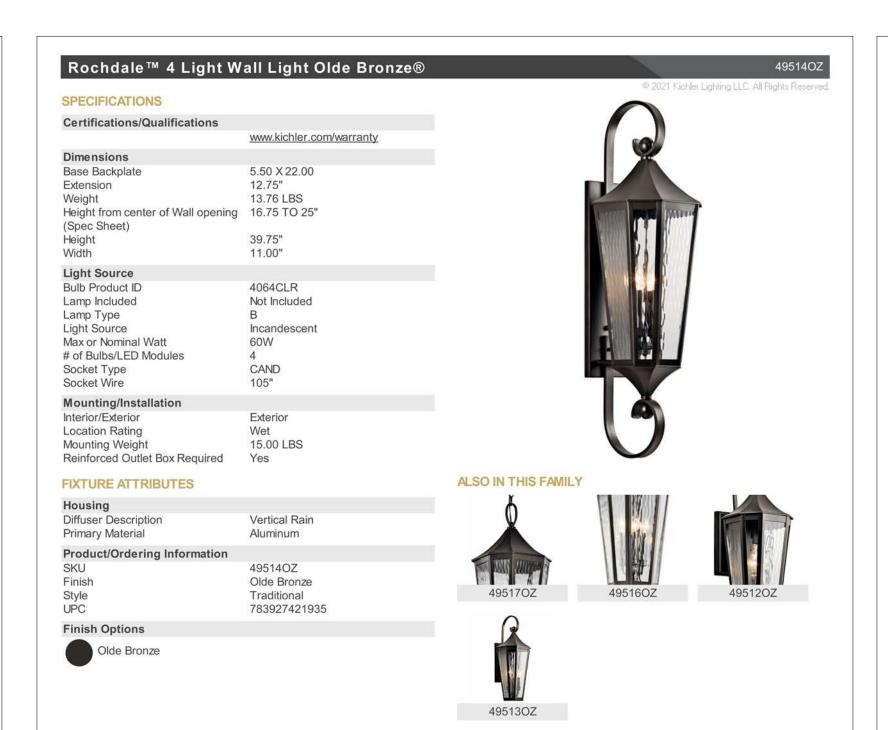

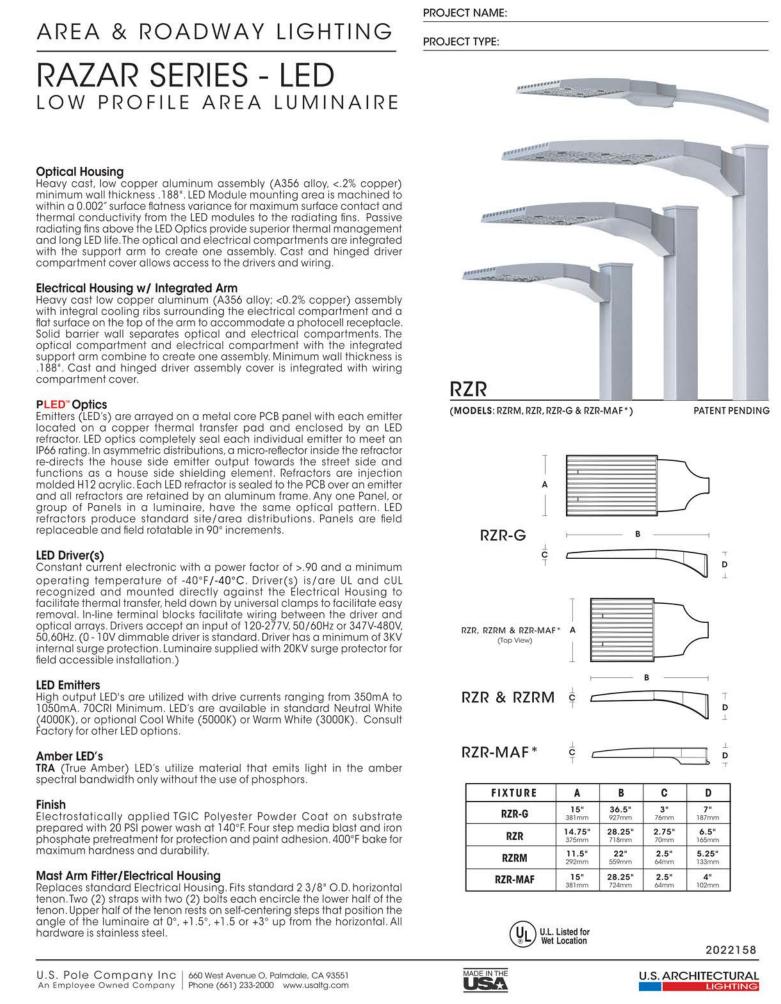


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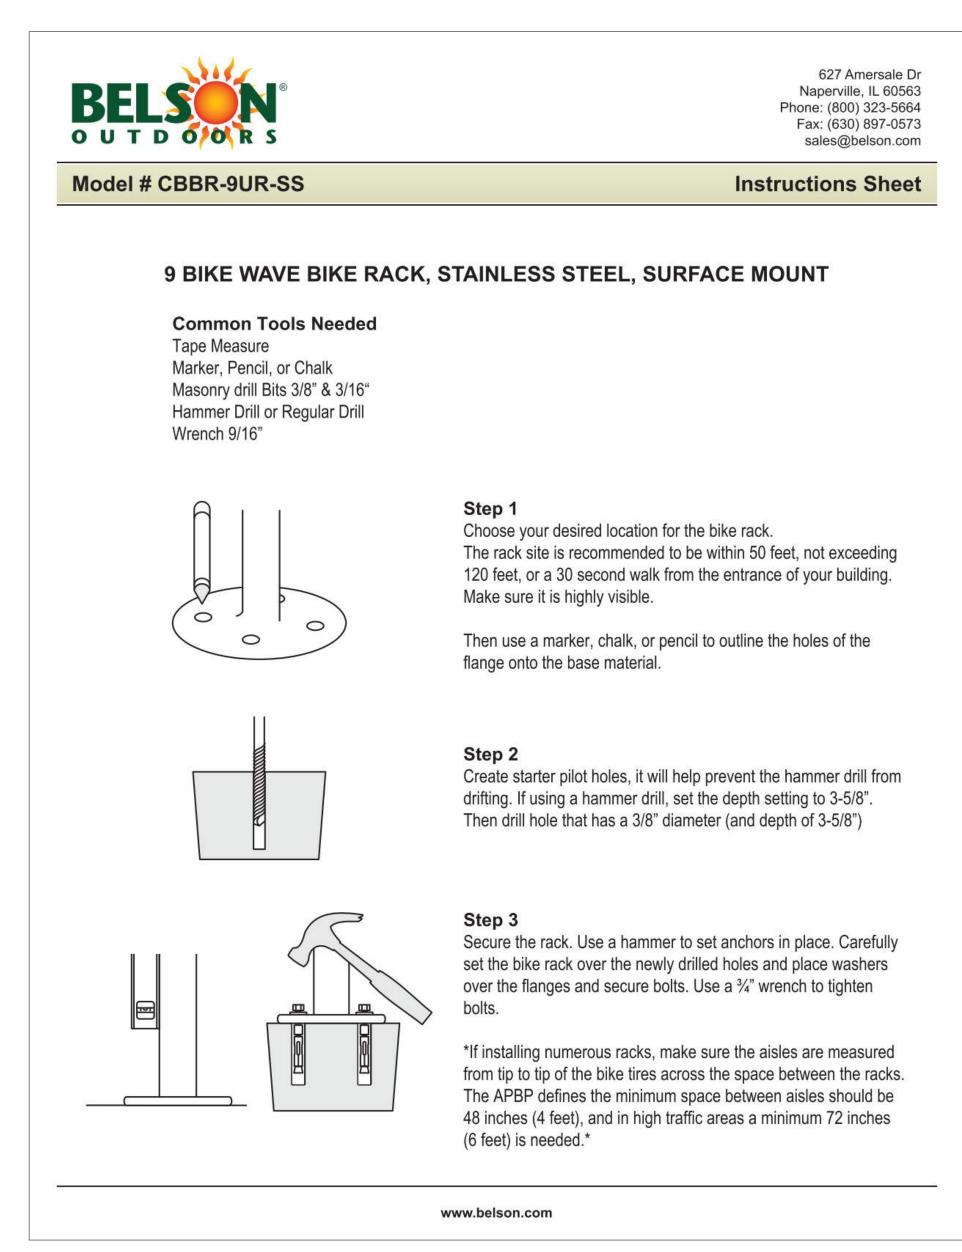
Kichler.com

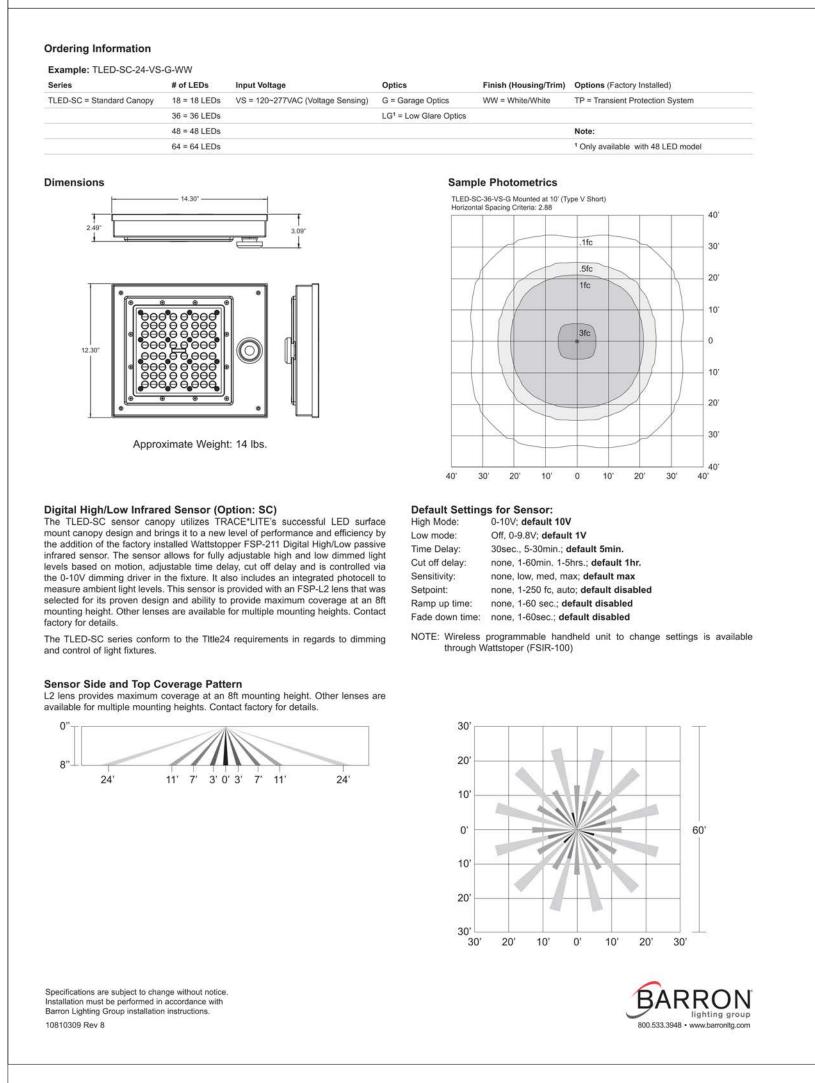

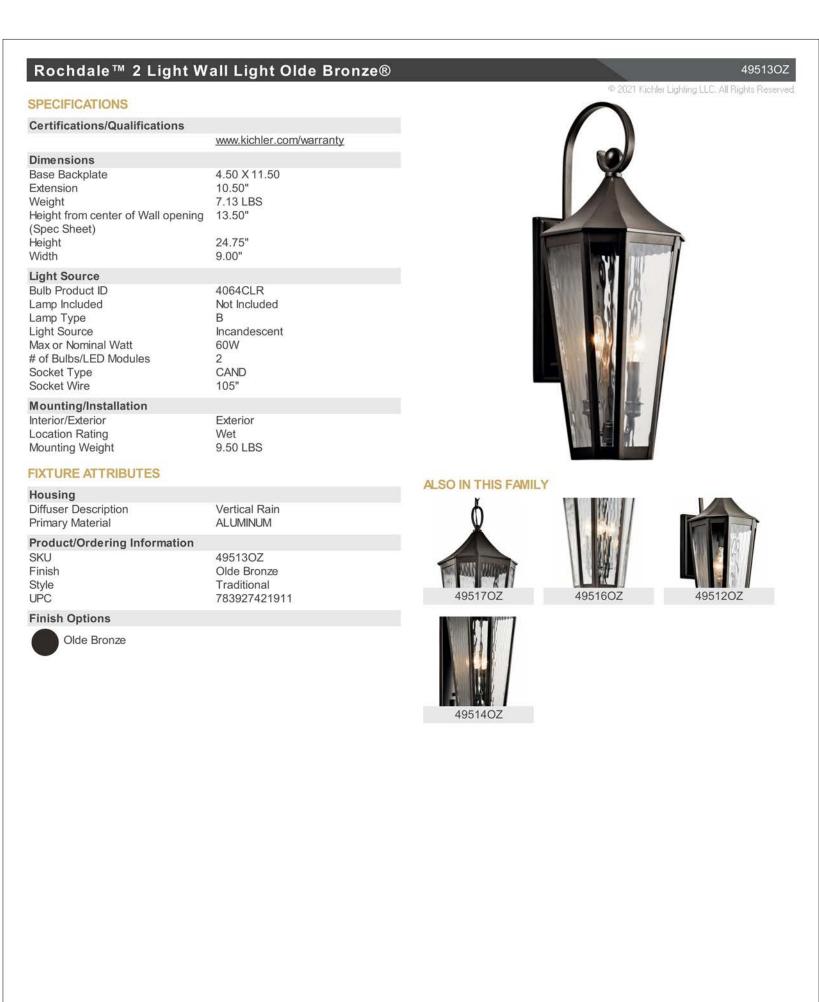

SCAN FOR FULL RAZAR LIGHTING SPECS (15 PAGES) Product Information Customer Review Product Q&A Accessories Recessed Vertical 1250 Series, 6 Door Mailbox, Anodized Aluminum Weights & Dimensions Florence vertical mailboxes have long been the ideal solution for small apartment homes. Constructed of corrosion resistant anodized aluminum, these recessed mounted mailboxes are the product of 6-3/8 in choice for facilities with limited wall cavity space. The top-loading units are protected from the weather. Feature 5-pin cylinder tenant cam locks with two keys (1,000 key changes) and resident name and Width 35-5/8 in number ID card holders. Verticals are USPS STD-4B+ approved for replacement uses. Warranty of 5 Mailbox Dimensions (W x D x H) 5-1/2" x 6" x 16" 19-1/8 in Recessed Vertical 1250 Series, 6 Door Mailbox, 35 lbs **Anodized Aluminum** Item #: T97B684168 Product Details ***<u>*</u> Enter zip code for delivery date estimate Mounting Location Recessed Wall Mounted Assembly Required Assembled Number of Mailboxes Top Loading Master Access Florence **FOR FURTHER INFORMATION** Package Quantity URL: https://www.globalindustrial.com/p/recessed-vertical-1250-Series 1250 series-6-door-mailbox-anodized-aluminum?ref=42 Material Aluminum Recessed Manufacturers Part Number 1250-6HA Color Family Silver Warranty Compliance & Certifications

Certifications

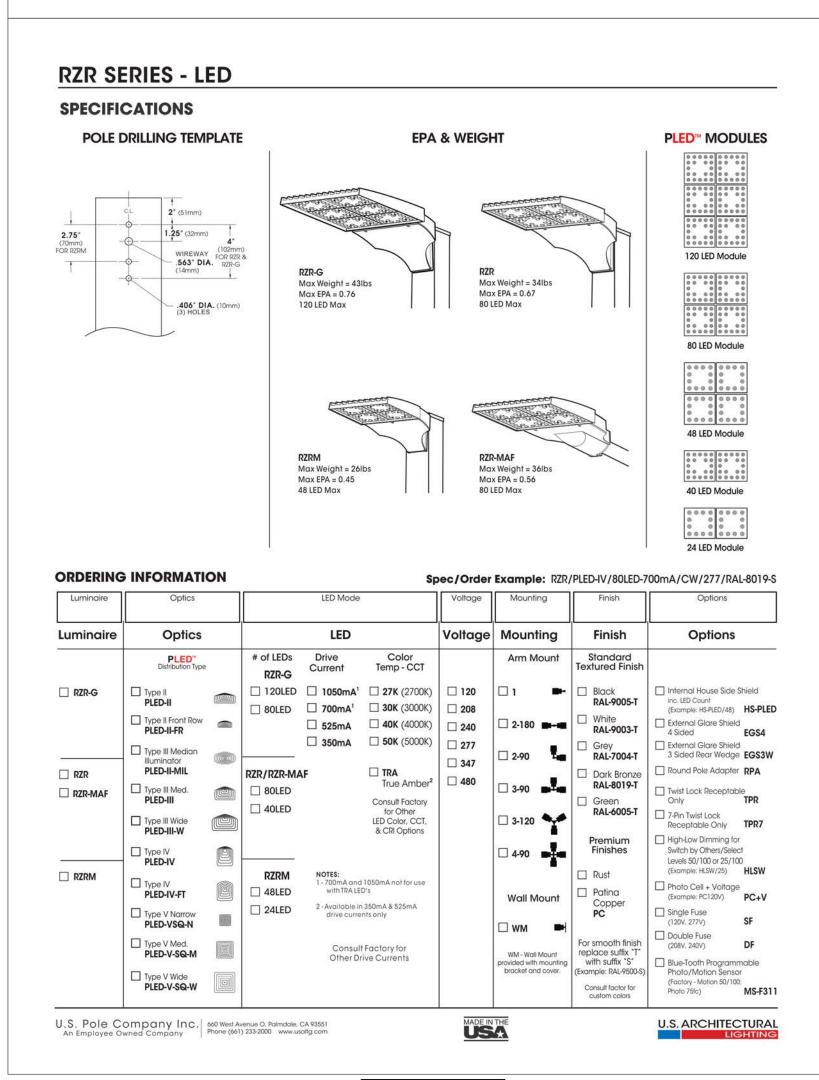

PA22-0929, PA22-0930, PA22-0931 SUBMITTAL #5

USPS-STD-4B+ for Replacement



OM DEVELOPMENT

AND CONSTRUCTION

Consultant:

Walter R. Allen

Architect + Associates

License Number:

APN: 922-100-048

BLOCK NUMBER: M.B. 15/726 LOT #2 BLOCK 3:

SPECIFICATION


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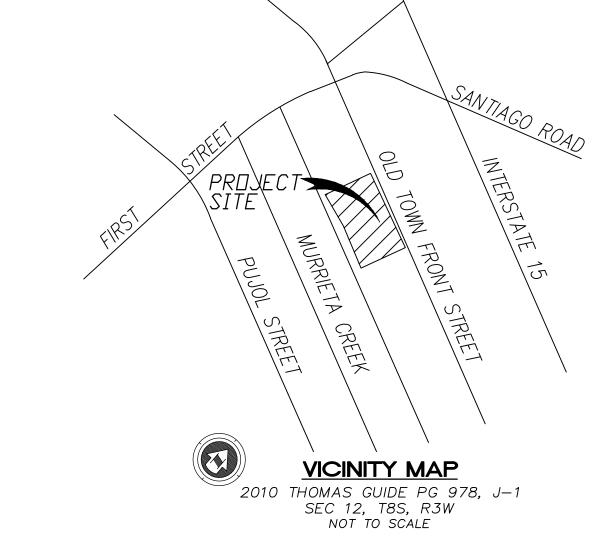
Date: 5/17/2023

Scale:

SHEET NUMBER
E1.2

OLD TOWN FRONT STREET HOTEL PORTION LOT 2, MB 15 / 726



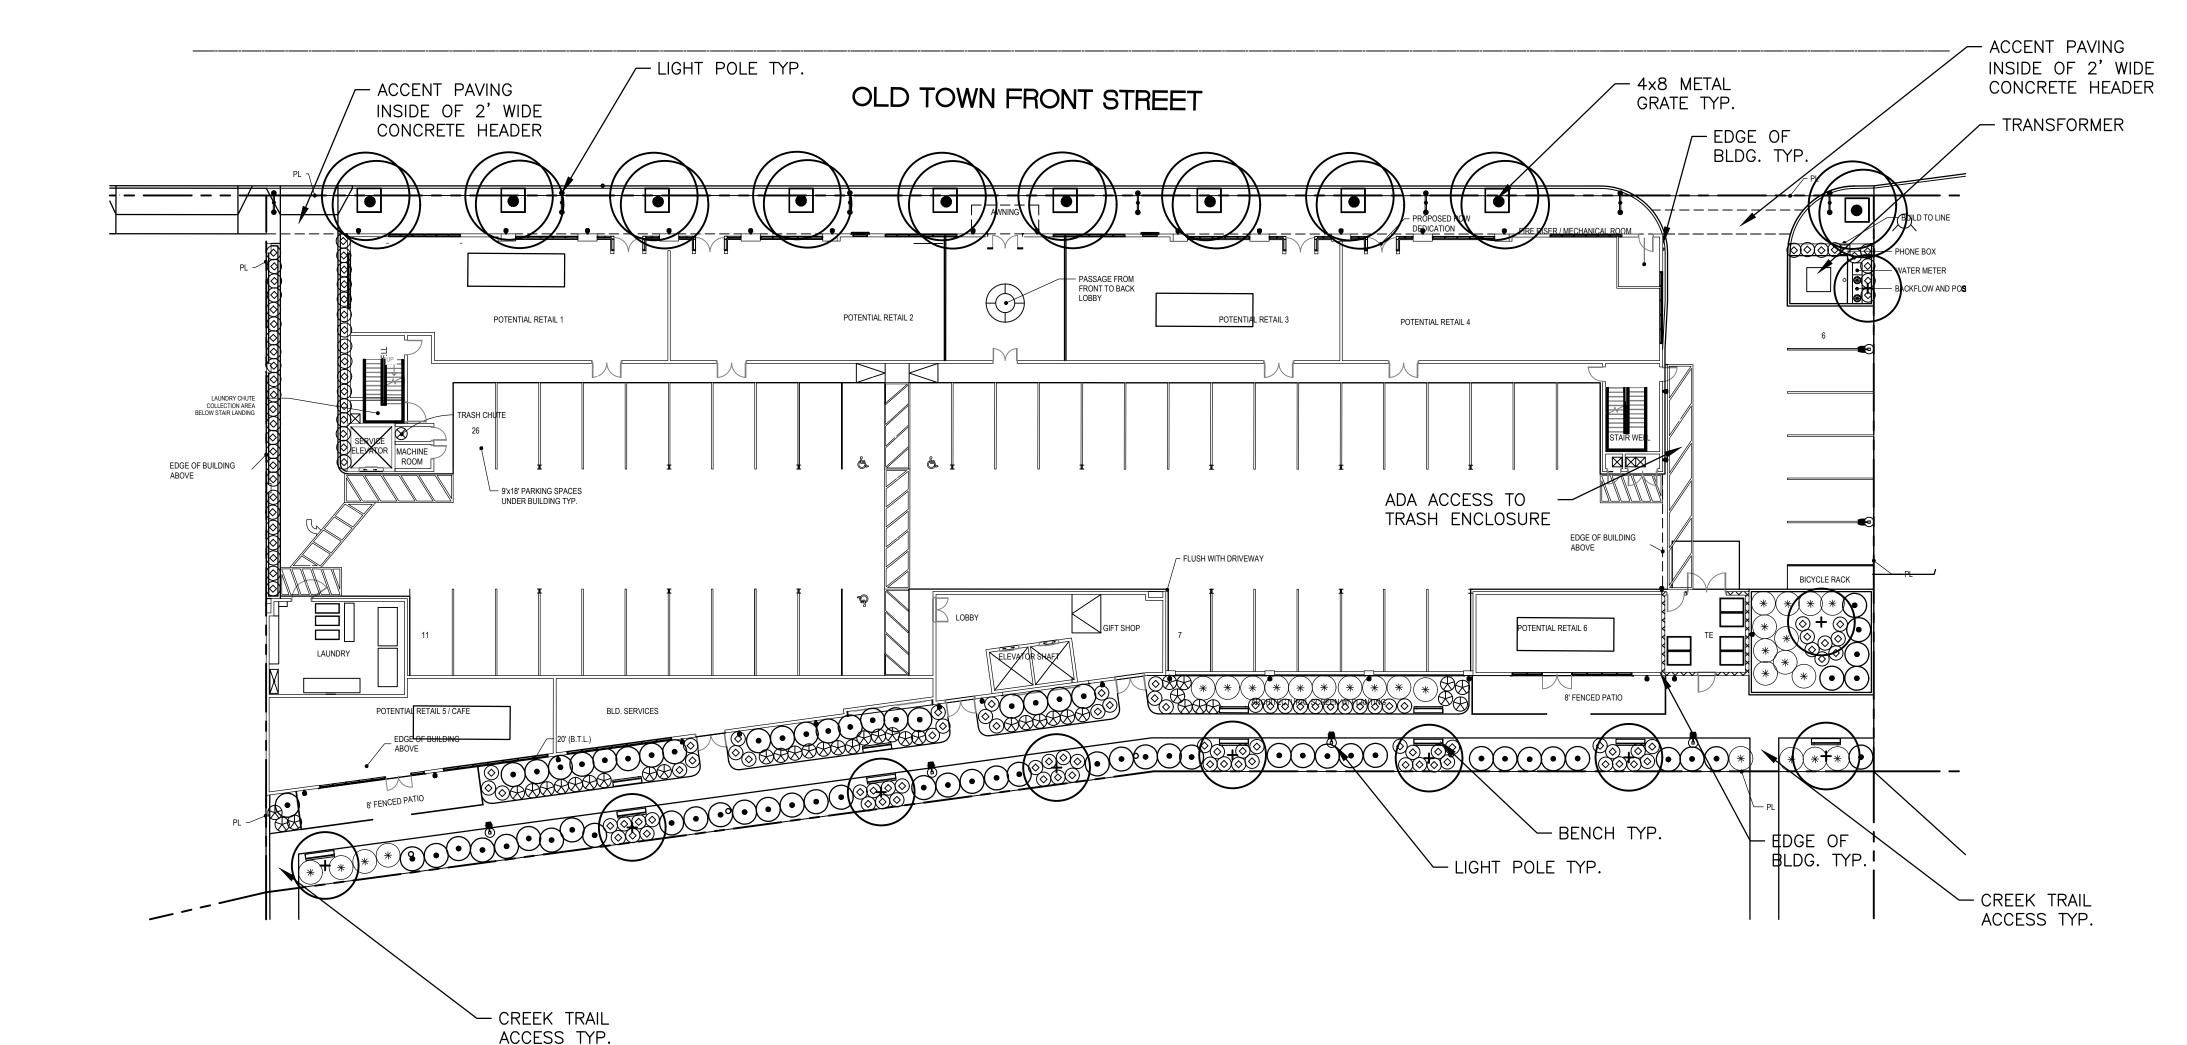

PROJECT DATA:

1.) ASSESSOR'S PARCEL NO.: 922-100-048

2.) PROJECT NAME: OLD TOWN FRONT STREET HOTEL

3.) LEGAL DESCRIPTION: LOT 2 IN BLOCK 32 OF THE TOWN OF TEMECULA, AS SHOWN BY MAP ON FILE IN BOOK 15 PAGE 726, OF MAPS, RECORDS OF SAN DIEGO COUNTY, CALIFORNIA;

COUNTY FLOOD CONTROL AND WATER CONSERVATION DISTRICT BY A FINAL ORDER OF CONDEMNATION RECORDED APRIL 3, 2009 AS INSTRUMENT NO. 09—163110 AND JULY 29, 2010 AS INSTRUMENT NO. 10—355371, BOTH OF OFFICIAL RECORDS.

- 4.) ZONING DESIGNATION: (DOWNTOWN CORE DISTRICT)
 GENERAL PLAN: SC (SERVICE COMMERCIAL)
 SPECIFIC PLAN AREA: SP-5
 EXISTING LAND USE/PROPOSED LAND USE: VACANT / HOTEL
- 5.) SOURCE OF TOPOGRAPHY: SPIRO LAND SURVEYING DATED
- 6.) THIS PROPERTY IS WITHIN FEMA MAP 06065C3285G, AND IS NOT WITHIN A FEMA FLOODPLAIN OR FLOODWAY.
- 7.) TOTAL GROSS AREA: 42,519 S.F. 0.97 ACRES TOTAL NET AREA: 42,519 S.F. 0.97 ACRES TOTAL BUILDING AREA:
- 8.) PARKING: 47 STANDARD SPACES 3 ADA SPACES
- 9.) LANDSCAPING IS PROPOSED IN THE CITY RIGHT—OF—WAY. CITY RIGHT—OF—WAY LANDSCAPING WILL BE MAINTAINED BY THE PROPERTY OWNER.

10.) GROSS AND DISTURBED ACREAGE: 6.09 AC

SITE CALCULATIONS

SITE AREA 42,519 SQ. FT. 0.976 NET ACRES

TOTAL LANDSCAPE AREA 4,684 SQ. FT. 11% OF TOTAL SITE

LANDSCAPE AREA IN R.O.W. 320 SQ. FT.


ALL IDEAS, DESIGNS, & ARRANGEMENTS REPRESENTED HEREON ARE THE PROPERTY OF ALHAMBRA GROUP LANDSCAPE ARCHITECTS. ANY CHANGE MADE BY PARTIES OTHER THAN SAID ARCHITECTS & SHALL RELIEVE ARCHITECTS OF RESPONSIBILITY FOR THE FACILITY OR AFFECTED PORTION THEREOF. CONTRACTORS SHALL VERIFY ALL DIMENSIONS AND CONDITIONS PRIOR TO THE FACILITY OR AFFECTED PORTION THEREOF. CONTRACTORS SHALL VERIFY ALL DIMENSION OF SAID ARCHITECTS. ANY CHANGE MADE BY PARTIES OTHER THAN SAID ARCHITECTS OF RESPONSIBILITY FOR THE FACILITY OR AFFECTED PORTION THEREOF.

PLANTING LEGEND

SYMBOL	BOTANICAL NAME	COMMON NAME	SIZE	NUMBER	REMARKS	WUCOL IV
	TREES					
(+)	CHITALPA TASHKENTENSIS	PINK FLOWERING CHITALPA	24" BOX	10	DOUBLE STAKE / HEIGHT 8-10', SPREAD 3'-4' MIN.	L
((•))	PLATANUS RACEMOSA	CALIFORNIA SYCAMORE	24" BOX	10	DOUBLE STAKE / HEIGHT 8-10', SPREAD 3'-4' MIN.	M
	SHRUBS					
⊗	WESTRINGIA FRUTICOSA 'MORNING LIGHT'	MORNING LIGHT WESTRINGIA	5 GAL	134	FULL & BUSHY @ 3' O.C.	
	LEUCOPHYLLUM FRUTESCENS 'GREEN CLOUD'	GREEN CLOUD TEXAS SAGE	1 GAL	67	FULL & BUSHY @ 5' O.C.	L
\otimes	HESPERALOE PARVIFLORA	RED YUCCA	5 GAL	40	FULL & BUSHY @ 3' O.C.	
*	WESTRINGIA FRUTICOSA 'MUNDI'	PROSTRATE WESTRINGIA	1 GAL	28	FULL & SPREADING @ 5' O.C.	
	MULCH:					·
NOT SHOWN	FOREST BLEND WOOD MULCH	SHREDDED WOOD MULCH	3" MAX.	AS REQ'D.	3" DEEP-TO ALL PLANTING AREAS TYP.	
		•	•	•		

NOTES:

- 1. ALL PLANTING AND IRRIGATION SHALL CONFORM TO THE CITY OF TEMECULA WATER EFFICIENCY ORDINANCE 17.32.
- 2. A DRIP IRRIGATION SYSTEM SHALL BE UTILIZED FOR THIS PROJECT PER THE CITY OF TEMECULA'S WATER CONSERVATION ORDINANCE. NO SPRAY IRRIGATION SHALL BE USED.
- 3. ALL MATURE PLANTING SHALL NOT INTERFERE WITH UTILITY LINES OR TRAFFIC SITE LINES.
- 4. ALL UTILITIES SHALL BE SCREENED W/ PLANTING TYP.
- 5. CITY OF TEMECULA PLANNING DEPT. SHALL BE CALLED PRIOR TO ANY INSTALLATION IN ORDER TO SCHEDULE REQUIRED LANDSCAPE INSPECTIONS.
- 6. TREES & SHRUBS SHALL BE PLACED A MINIMUM OF 5' AWAY FROM WATER METER, GAS METER, OR SEWER LATERALS; A MINIMUM OF 10' AWAY FROM UTILITY POLES; & A MINIMUM OF 8' AWAY FROM FIRE HYDRANTS & FIRE DEPARTMENT SPRINKLER & STANDPIPE CONNECTIONS.

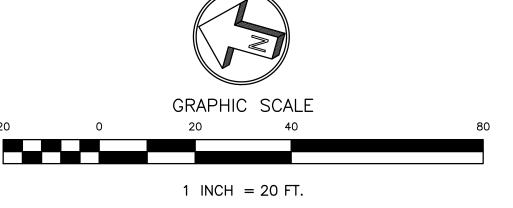

PA22-0929, PA22-0930, PA22-0931 SUBMITTAL #3

PRELIMINARY PLANTING PLAN

APN # 922-100-048 PA22-0929/0930/093


REVISED

SRA GROUP

ARCHITECTURE

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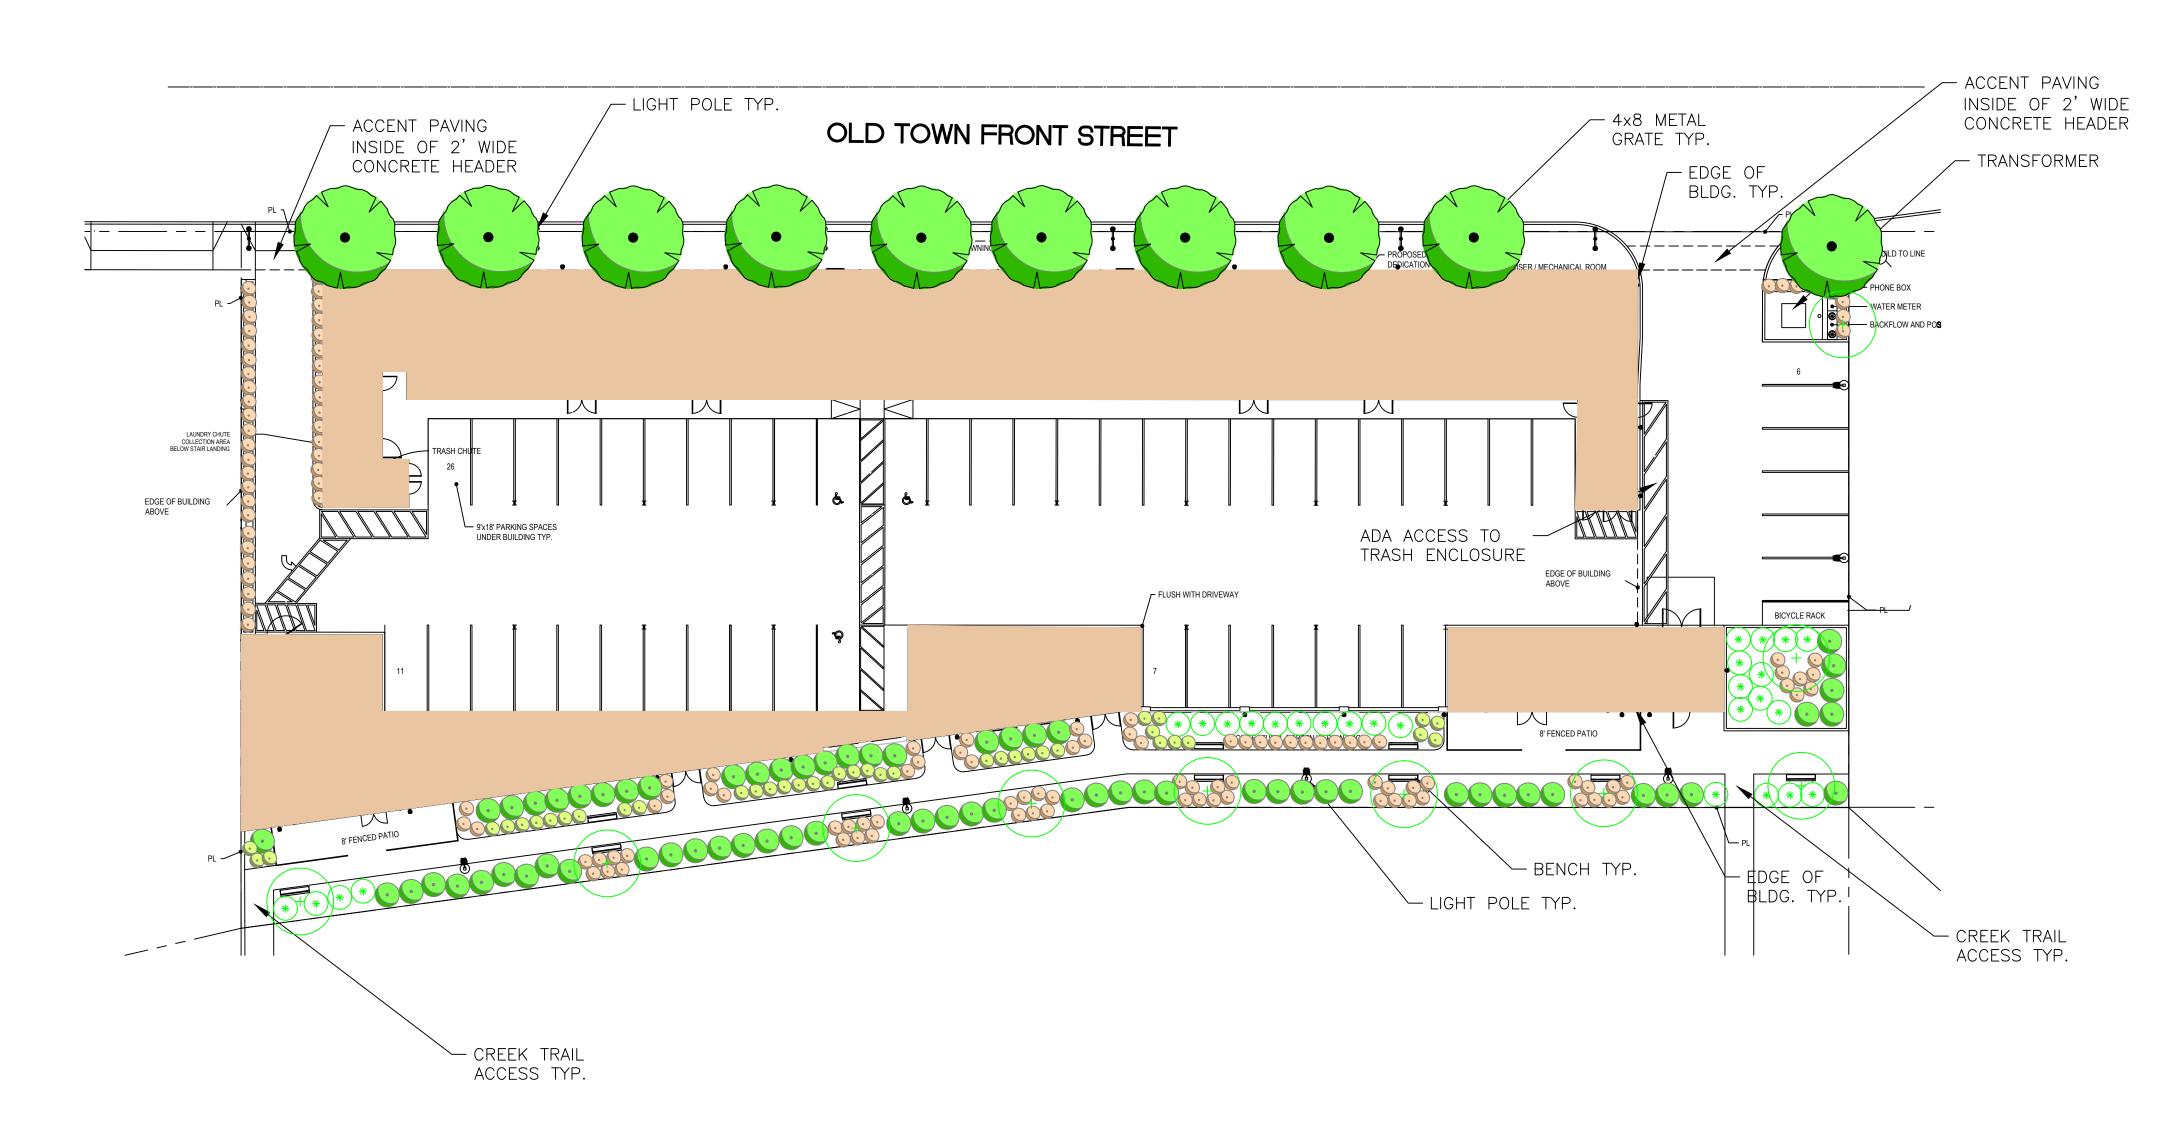
ALHAMBHA C
LANDSCAPE ARCH
California license
RECREATION FACILITIES




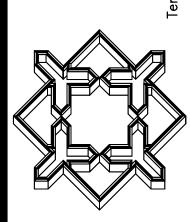

SHEET L-1 of 1 sheets

JOB NO. 22-116



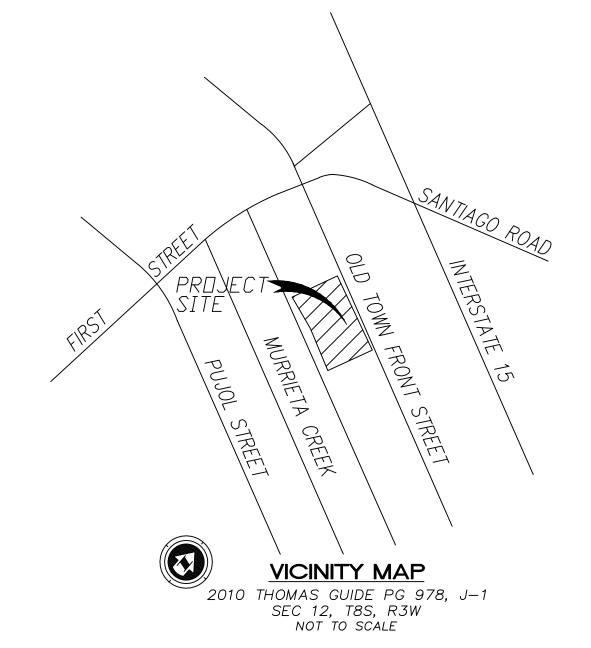

SITE CALCULATIONS

SITE AREA 42,519 SQ. FT. 0.976 NET ACRES

TOTAL LANDSCAPE AREA 4,684 SQ. FT. 11% OF TOTAL SITE

LANDSCAPE AREA IN R.O.W. 320 SQ. FT.


THE ALL IDEAS, DESIGNS, & ARRANGEMENTS REPRESENTED HEREON ARE THE PROPERTY OF ALL RELIEVE ARCHITECTS OF RESPONSIBILITY FOR THE FACILITY OR AFFECTED PORTION THEREOF. CONTRACTORS SHALL VERIFY ALL DIMENSIONS AND CONDITIONS PRIOR TO THE START OF ANY WORK & SHALL REPORT ANY DISCREPANCY TO THE ARCHITECTS SHALL VERIFY ALL DIMENSIONS AND CONDITIONS PRIOR TO THE START OF ANY WORK & SHALL REPORT ANY DISCREPANCY TO THE ARCHITECTS SHALL VERIFY ALL DIMENSIONS AND CONDITIONS PRIOR TO THE START OF ANY WORK & SHALL REPORT ANY DISCREPANCY TO THE ARCHITECTS AND THE ARCHITECTS

PLANTING LEGEND

SYMBOL	BOTANICAL NAME	COMMON NAME	SIZE	NUMBER	REMARKS	WUCOL IV
	TREES					
(+)	CHITALPA TASHKENTENSIS	PINK FLOWERING CHITALPA	24" BOX	10	DOUBLE STAKE / HEIGHT 8-10', SPREAD 3'-4' MIN.	L
	PLATANUS RACEMOSA	CALIFORNIA SYCAMORE	24" BOX	10	DOUBLE STAKE / HEIGHT 8-10', SPREAD 3'-4' MIN.	M
	SHRUBS		•			-
•	WESTRINGIA FRUTICOSA 'MORNING LIGHT'	MORNING LIGHT WESTRINGIA	5 GAL	134	FULL & BUSHY @ 3' O.C.	L
$loodsymbol{\bullet}$	LEUCOPHYLLUM FRUTESCENS 'GREEN CLOUD'	GREEN CLOUD TEXAS SAGE	1 GAL	67	FULL & BUSHY @ 5' O.C.	L
•	HESPERALOE PARVIFLORA	RED YUCCA	5 GAL	40	FULL & BUSHY @ 3' O.C.	L
*	WESTRINGIA FRUTICOSA 'MUNDI'	PROSTRATE WESTRINGIA	1 GAL	28	FULL & SPREADING @ 5' O.C.	L
	MULCH:		1			
NOT SHOWN	FOREST BLEND WOOD MULCH	SHREDDED WOOD MULCH	3" MAX.	AS REQ'D.	3" DEEP-TO ALL PLANTING AREAS TYP.	

NOTES:

- 1. ALL PLANTING AND IRRIGATION SHALL CONFORM TO THE CITY OF TEMECULA WATER EFFICIENCY ORDINANCE 17.32.
- 2. A DRIP IRRIGATION SYSTEM SHALL BE UTILIZED FOR THIS PROJECT PER THE CITY OF TEMECULA'S WATER CONSERVATION ORDINANCE. NO SPRAY IRRIGATION SHALL BE USED.
- 3. ALL MATURE PLANTING SHALL NOT INTERFERE WITH UTILITY LINES OR TRAFFIC SITE LINES.
- 4. ALL UTILITIES SHALL BE SCREENED W/ PLANTING TYP.
- 5. CITY OF TEMECULA PLANNING DEPT. SHALL BE CALLED PRIOR TO ANY INSTALLATION IN ORDER TO SCHEDULE REQUIRED LANDSCAPE INSPECTIONS.
- 6. TREES & SHRUBS SHALL BE PLACED A MINIMUM OF 5' AWAY
 FROM WATER METER, GAS METER, OR SEWER LATERALS;
 A MINIMUM OF 10' AWAY FROM UTILITY POLES; & A MINIMUM
 OF 8' AWAY FROM FIRE HYDRANTS & FIRE DEPARTMENT SPRINKLER
 & STANDPIPE CONNECTIONS.

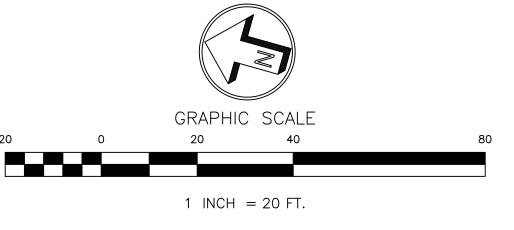

PA22-0929, PA22-0930, PA22-0931 SUBMITTAL #4


COLOR CONCEPT PLAN

APN # 922-100-048 PA22-0929/0930/0931

REVISED

RA GROUP ARCHITECTURE icense #2017

ALHAMBRA GRC
ANDSCAPE ARCHITEC
California license #20
Recreation facilities pla

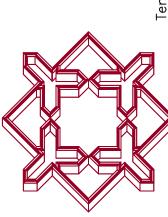



REGISTER OF THE PROPERTY OF TH

TIAL REAL ESTATE, LLC
TREET, BAKERSFIELD, CA. 93311-9273

OM RESIDENTIAL 11606 HARRINGTON STREET, PH(661) 699-5194 EMAIL: 8am

OWNER:

drawn: V.D.
checked: V.D.
date: 5-22-23

SHEET L-1
of 1 sheets

of 1 sheets JOB NO.