



	INDE	EX TO DRAWIN
	PROJECT CALC	PROJECT INFO., VICINITY MAP, CULATIONS, OVERALL SITE PLAN. & PLANS 1ST & SECOND FLOOR
	P	ROJECT TEAM
	<u>OWNER:</u>	STAMPEDE 28721 OLD TOWN FRONT STREET TEMECULA CA 92590 CONTACT: KEN NEWMAN EMAIL: KEN@NHG.NET
	ARCHITECT:	WALTER R. ALLEN, AIA 28465 OLD TOWN FRONT STREET, SUITE 2 TEMECULA, CA 92590 TEL: (951) 693-0301 CONTACT: CHRIS CAMPBELL EMAIL: CHRIS@RQTEX.COM
(E) FIRE HYDRANT	<u>STRUCTURAL:</u>	HTK STRUCTURAL ENGINEERS 14288 DANIELSON STREET, SUITE 200 POWAY, CA 92064 TEL: (858) 679-8989 CONTACT: BEN SEIBEL
	MECHANICAL: ELECTRICAL: PLUMBING:	SALAS O'BRIEN 3220 EXECUTIVE RIDGE, SUITE 210 VISTA, CA 92081 TEL: (858) 679-8989 CONTACT: STEVEN BARROW
	PRO	JECT INFORM
	PROJECT SCOPE: UTIL WATER: RANCH	922-073-026         26721 OLD TOWN FRONT STREET, TEMECU         REFER TO TITLE REPORT         SP-5, DTC - DOWNTOWN CORE (HOTEL OV         SP-5, OLD TOWN SPECIFIC PLAN         61,199 SF       1.40 ACRES         51,250 SF       1.18 ACRES         36,706 SF       0.60         11,420 SF       (FIRST FLOOR 8,481 SF 4 SECO         SQUARE FEET       PERCENTAGE         36,706 SF       60%         11,762 SF       19%         16,019 SF       32%         1,199 SF       2%         4,688 SF       9%         NONE REQUIRED, NONE PROPOSED       0.60         A-2       V-B         FULLY-SPRINKLERED, NFPA 13 COMPLIANT       TWO         APPROX. 31'-8 5/8"       - CALIFORNIA RESIDENTIAL CODE 2022 ED.         - CALIFORNIA RESIDENTIAL CODE 2022 ED.       - CALIFORNIA RESIDENTIAL CODE 2022 ED.         - MECHANICAL:       CALIFORNIA PLUMBING CODE         - CALIFORNIA RESIDENTIAL CODE 2022 ED.       - CALIFORNIA RESIDENTIAL CODE 2022 ED.         - CALIFORNIA RESIDENTIAL CODE 2022 ED.       - CALIFORNIA FRE CODE 2022 ED.         - MECHANICAL:       CALIFORNIA PLUMBING CODE         - OLLIFORNIA FRE CALIFORNIA PLUMBING CODE       - PLUMBING: CALIFORNIA PLUMBING CODE         - FIRE:       <
	ELECTRIC: SOUTHE	ERN CALIFORNIA GAS TEL. (800) ERN CALIFORNIA EDISON TEL. (800) DN - BUSINESS TEL. (800) TEL. (800) TEL. (800)
		/ICINITY MAP:
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IGS	Designed cac Drawn By nm Checked wra Date 07/10/2023
ATION ULA CA 92590, SUITE B (ERLAY) OND FLOOR - 2,939 SF) OND FLOOR - 2,939 SF)	OAK & OCEAN 28721 Old Town Front Street, Temecula, CA 92590, SUITE B
NT WY LIVE LCOHOL RS: 296-6900 428-3717 427-2000 940-7188 483-3000 826-977	Image: series of the series of th
SITE	Drawing Number

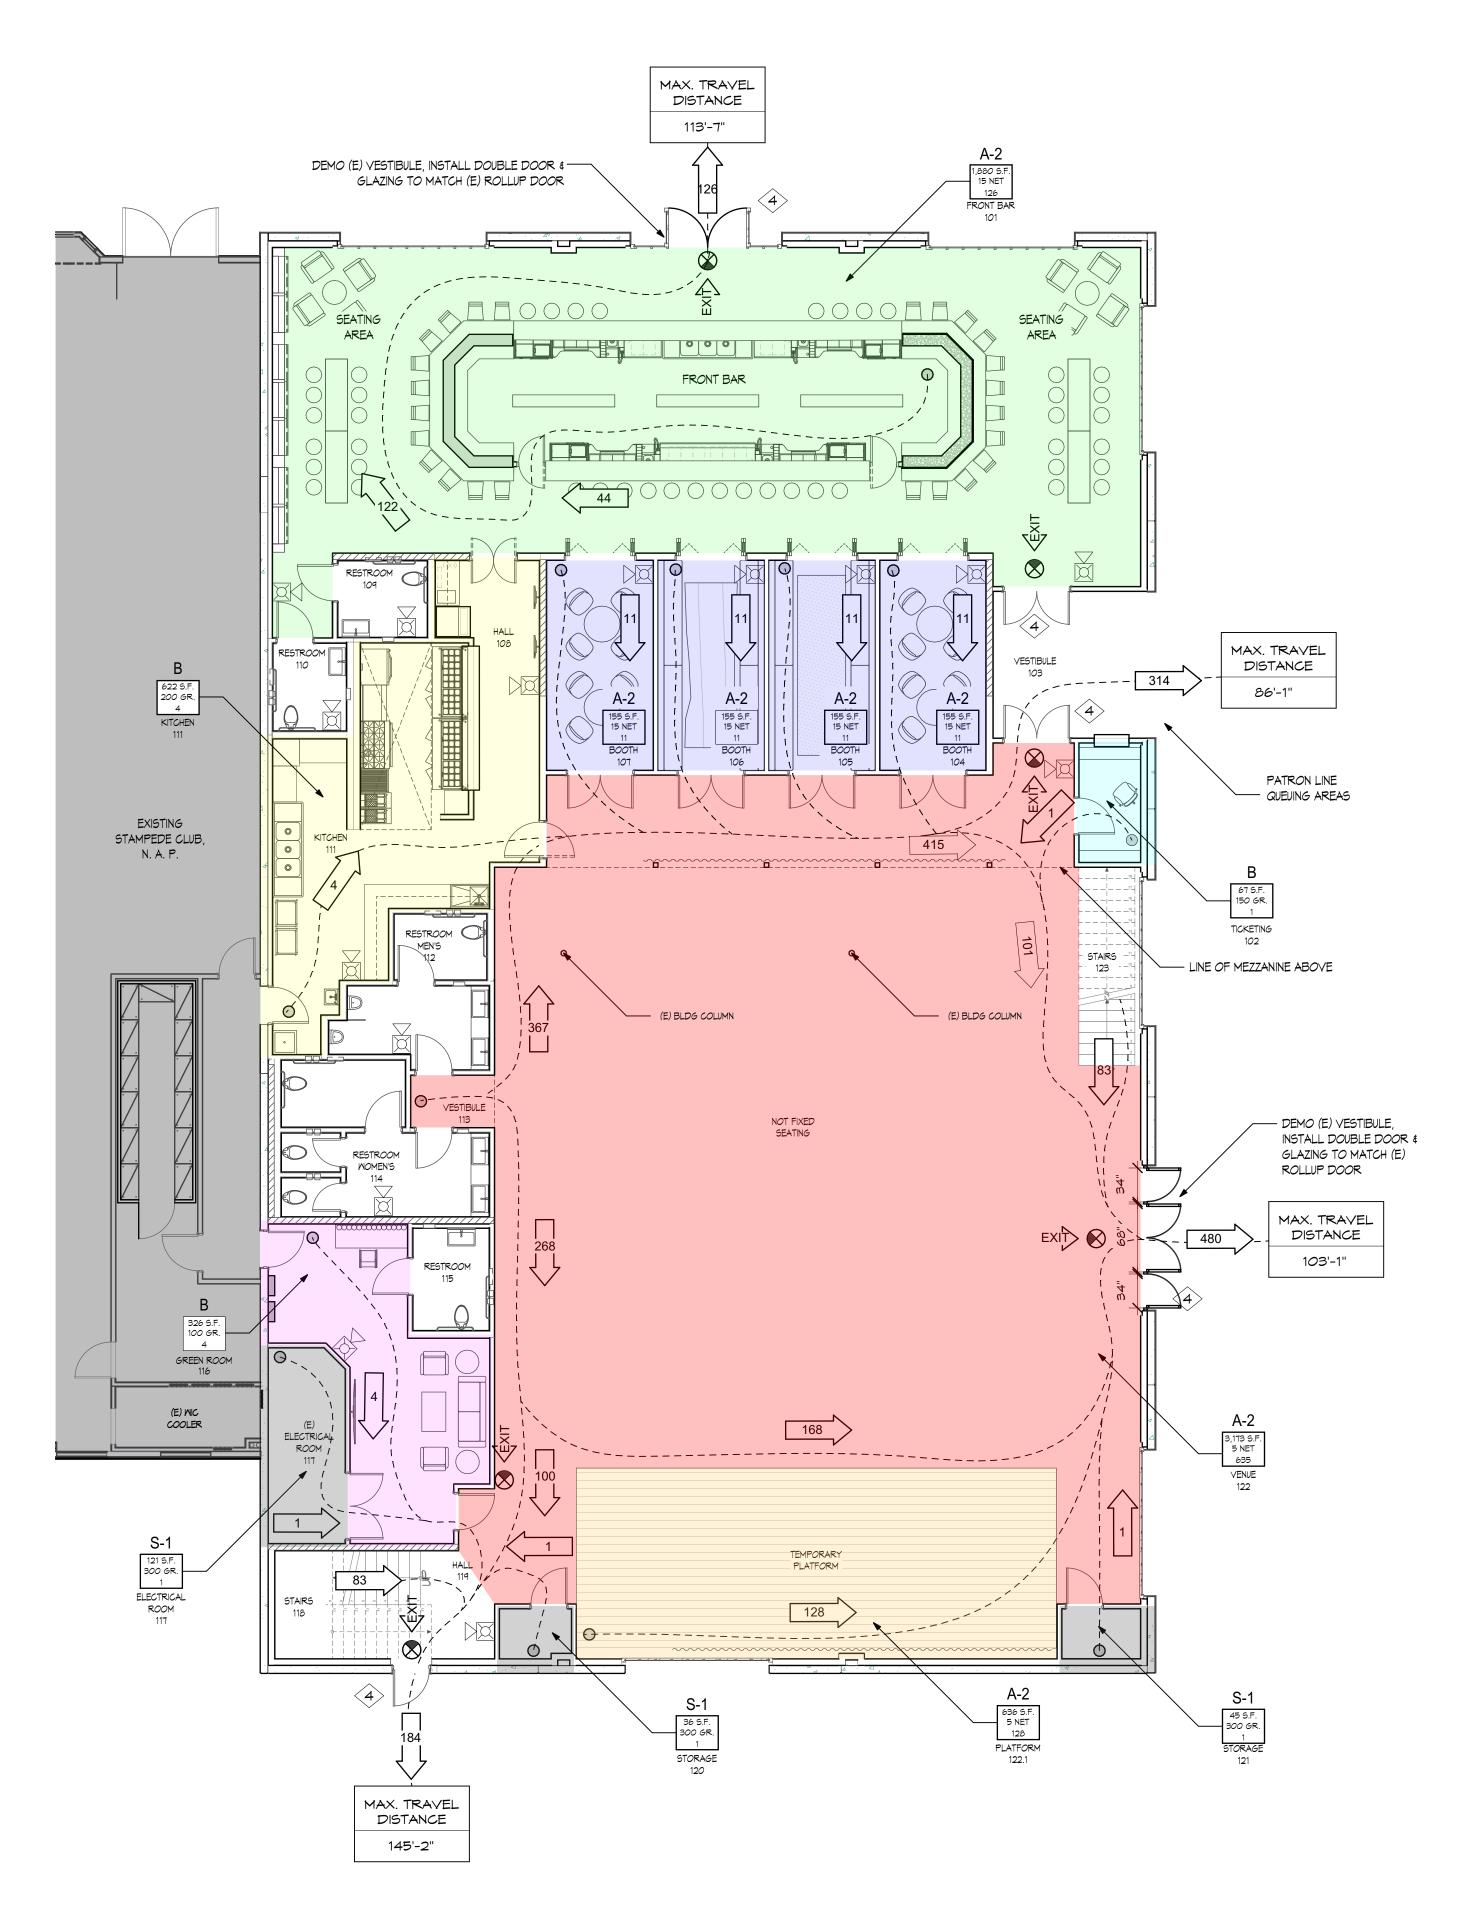


FIRST FLOOR - VENUE / FRONT BAR - EXITING PLAN

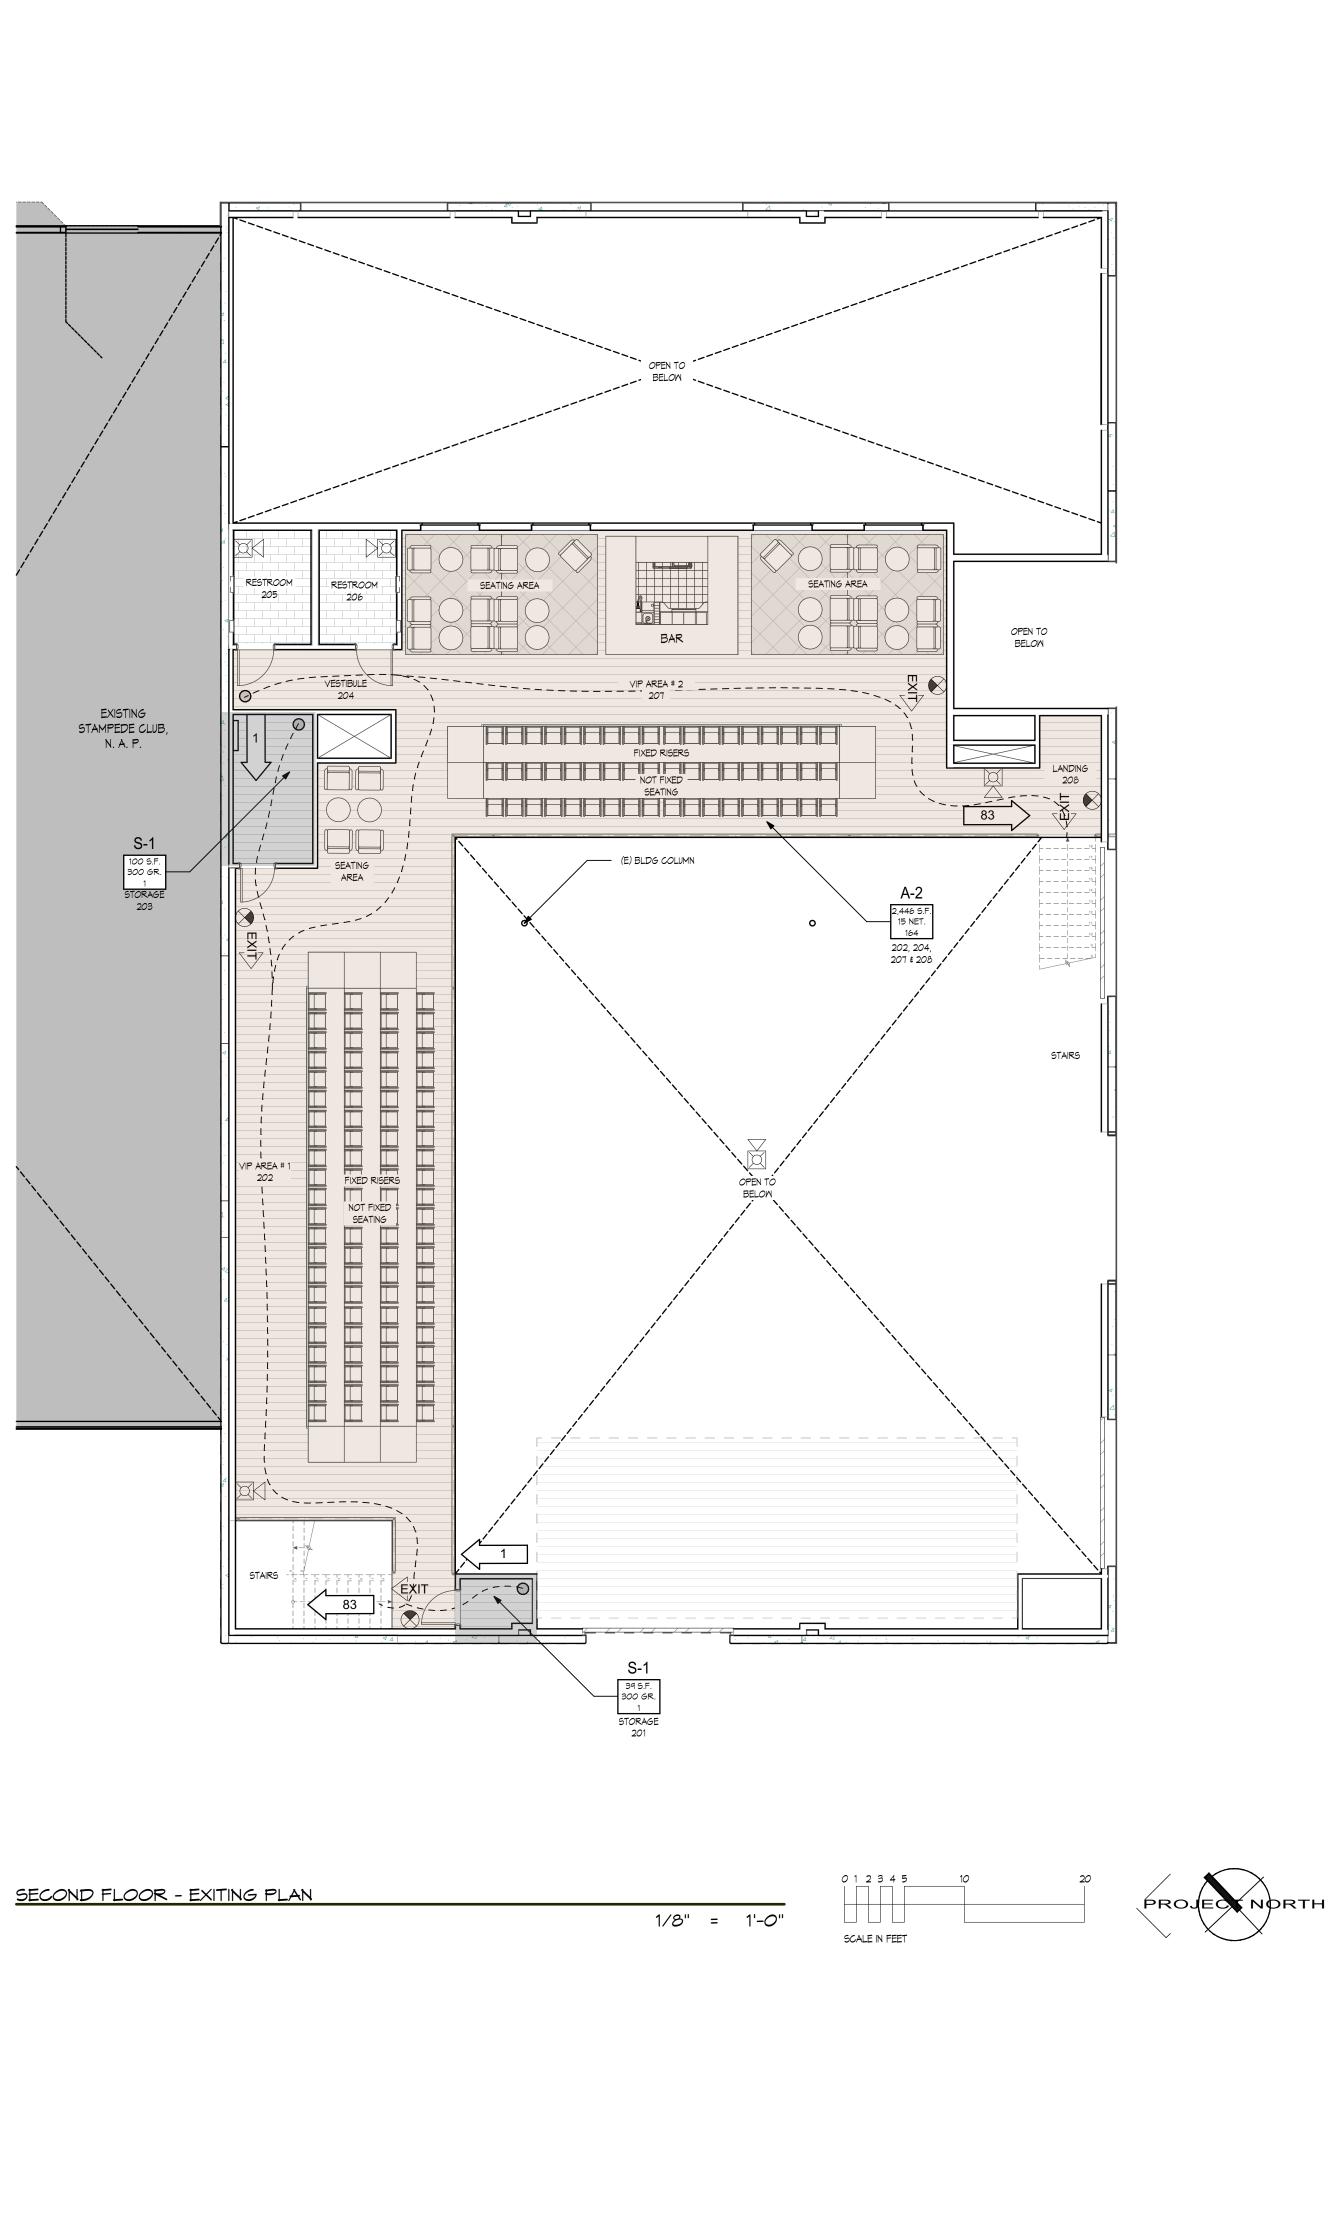


1/8" = 1'-0"

1. <u>EXITII</u> 1. 2.	FIRE SPRINK PANEL, LOC FIRE DEPAR ON SITE PLA ESIBILITY ALL EXTERIC 2% MAX SLO THE DOOR I NG NOTES IF THE BUILD SPRINKLER MODIFICATIO SUBMITTED , UNDER A SE PROVIDE EV ROUTES FOR REQUIREMEN	ATION OF TMENT CC N SHEET A NOTES OR DOOR OPE IN ALL NCLUDING SYSTEM IT ON TO SPF AND APPR PARATE P (ACUATION R NEARES NTS	KNOX BO DNNECTION A101. LANDINGS DIRECTION REQUIRED SHALL R RINKLER F 20VED BY FERMIT. N PLANS M T EXIT PER	IX AND LC N CAN AL B SHALL I DNS, 4' D D SIDE CL TH AN AU EMAIN EG CLANS SH, THE FIRE	DCATION OF L BE LOCAT BE ACCESSI EEP X WIDT LEARANCES TOMATIC FI RUIPPED. AN ALL BE E DEPARTM LIGHTED Y OF TEMEC	= TED IBLE. H OF RE Y ENT	Walter R. Allen, AIA 28465 Old Town Front Street, Suite 201 Temecula, CA 92590 ph (951) 693-0301	
3.	LOCATION(S EXTINGUISHE CALIFORNIA THE CALIFOI PLACEMENT TO FIRE CLE OCCUPANCY PLEASE REF	RS SHALL CODE OF RNIA FIRE IS SUBJEC EARANCE F	BE IN AC RESOLUT CODE ST, T TO THE FOR THE (	CORDANI TONS (CO ANDARD FIRE INS CERTIFICA	CE WITH THE R, TITLE 19 10-1, PECTOR PR ATE OF	1, AND	CHRISTOPHER ALLEN CAMPBELL C38929 CHILE C000 CON FILE C000 CON CSS22 CONTECTION CSS22 CONTECTION CSS22 CONTECTION CSS22 CONTECTION CSS22 CONTECTION CSS22 CS	à <b>k</b>
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X	NEW HOR FOR REFI EXISTING VERIFY M EXISTING LOCATION	N & STROE ERENCE O SURFACE IOUNTING + FIRE RISEI N.	NLY. MOUNTED +72" AFF. 5 R ROOM 4	KNOX BO BEE SITE \$ KNOX B	OX, PLAN FOR		North Street, Teme	
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CCUF FLOOR ROOM FRONT E FLOOR ROOM FRONT E TICKETIN VESTIBU 300TH	NEW HOR FOR REFI EXISTING LOCATION PANT LOAN PANT	N & STROE         ERENCE O         SURFACE         SURFACE         INCL.         2,099         67         169         326         326         326         326         36         NCL.         79         70         2,654         INCL.         2,939         AD - 1ST 4 <td>NLY. MOUNTED +72" AFF. S R ROOM 3 5.F. (NET) 1,880 49 - 155 155 155 155 155 155 155</td> <td>KNOX BC DEE SITE F KNOX B DEE SITE F COCC. A-2 B - A-2 A-2 A-2 A-2 A-2 A-2 A-2 A-2 A-2 A</td> <td>PLAN FOR         RATIO         15 NET         150 NET         100 GR.         300 GR.         15 NET         300 GR.         15 NET         15 NET         15 NET         15 NET</td> <td>LOAD 126 1 1 1 1 1 1 1 1 1 1 1 1 1 1 1</td> <td></td> <td></td>	NLY. MOUNTED +72" AFF. S R ROOM 3 5.F. (NET) 1,880 49 - 155 155 155 155 155 155 155	KNOX BC DEE SITE F KNOX B DEE SITE F COCC. A-2 B - A-2 A-2 A-2 A-2 A-2 A-2 A-2 A-2 A-2 A	PLAN FOR         RATIO         15 NET         150 NET         100 GR.         300 GR.         15 NET         300 GR.         15 NET         15 NET         15 NET         15 NET	LOAD 126 1 1 1 1 1 1 1 1 1 1 1 1 1 1 1		

	GENERAL NOT         1.       FIRE SPRINK         PANEL, LOG,         FIRE DEPAR         ON SITE PLA         ACCESIBILITY I         1.       ALL EXTERIO         2% MAX SLO         THE DOOR IN         EXITING NOTES         1.       IF THE BUILD         SPRINKLER S         MODIFICATIO         SUBMITTED A         UNDER A SER         2.       PROVIDE EV         REQUIREMEN         3.       LOCATION(S	LER RISEI ATION OF TMENT CC N SHEET / NOTES DR DOOR DPE IN ALL NCLUDING DYSTEM IT ON TO SPE AND APPR PARATE F ACUATION & NEARES ITS	KNOX BO DNNECTION A101. LANDINGS DIRECTIC REQUIRED UIPPED WI SHALL RI RINKLER P 20VED BY ERMIT. N PLANS W T EXIT PER	X AND LC X AND LC X CAN AL S SHALL I DNS, 4' D D SIDE CL TH AN AU EMAIN EG I'LANS SH, 'THE FIRE I'LH HIGHL X COUNTY ON(S) OF	DCATION OF L BE LOCAT BE ACCESSII EEP X WIDTH EARANCES. TOMATIC FIF CUIPPED. AN ALL BE E DEPARTME LIGHTED OF TEMECI FIRE	ED BLE. + OF RE Y ENT	Walter R. Allen, AIA 28465 Old Town Front Street, Suite 201 Temecula, CA 92590 ph (951) 693-0301
	4. PLEASE REF	CODE OF RNIA FIRE IS SUBJEC ARANCE I ER TO RE	RESOLUT CODE STA T TO THE FOR THE C	IONS (CC ANDARD FIRE INS CERTIFICA CEILING F	R), TITLE 19 10-1, PECTOR PR ATE OF PLAN FOR	I, AND	CHRISTOPHER ALLEN CAMPBELL C38929 ★ CAUPELL C38929 ★ CAUPELL C38929 ★ CAUPELL C38929 ★ CAUPELL C38929 ★ CAUPELL C38929 ★ CAUPELL C38929 ★ CHRISTOPHER ALLEN CAMPBELL C38929 ★ CHRISTOPHER CAUPELL CAU
	X-# OSF * * * * * * * * * * * * *		- OCCUPA - AREA - OCCUPA - NUMBER - ROOM U - ROOM N	NCY DES			Designed     cac       Drawn By     nm       Checked     wra       Date     07/10/2023
	EXIT DESIG EXIT DESIG EXIT DESIG EXIT DESIG EXIT EXIT D EXIT D	IGN - FLC DLUMINES R OF PER NATED MI IGN - CEIL DISCHARG E EXIT SIC E EXIT SIC E EXIT SIC E EXIT SIC WARE NARE NARE NARE SURFACE O SURFACE OUNTING	RSONS EX EANS OF E LING MOUN E SN READIN GN READIN GN READIN SN READIN SN READIN HNLY. MOUNTED +72" AFF. 9	LOCATIC	ED, IRECTION H LUMINATIO BTAIR UP" BTAIR DOWN DNS, DNS, DNS, DNS,		AK       & OCEAN         28721 Old Town Front Street, Temecula, CA 92590
	DCCUPANT LOAI		S.F. (NET)	<u>DNS</u> 0cc.	RATIO	OCCUPANCY LOAD	AK &
101	FRONT BAR TICKETING ROOM	(GR.) 2,099 67	(NET) 1,880 49	A-2 B	15 NET 150 GR.	126 1	
103	VESTIBULE	-	-	-	-	-	
104 105	BOOTH BOOTH	169 169	155 155	A-2 A-2	150 NET 150 NET	11	-
106 107	ВООТН ВООТН	169 169	155 155	A-2 A-2	150 NET 150 NET	11 11	-
108 109	HALL RESTROOM	INCL. 56	INCL. 48	-	-	0 0	_
11 <i>0</i>	RESTROOM	61 622	45 546	- B	- 200 GR.	0 4	-
112 113	RESTROOM VESTIBULE	141 INCL.	124 INCL.	-	-	0	
114	RESTROOM	220	177	-	-	0	-
115 116	RESTROOM GREEN ROOM	63 326	54 299	B	- 100 GR.	0 4	
117 118	(E) ELECTRICAL ROOM STAIRS	121 -	103 -	5-1 -	300 GR. -	1 0	
119 120	HALL STORAGE	- 36	- 24	- S-1	- 300 GR.	0 1	
121 122	STORAGE VENUE	45 3,264	27 3,173	5-1 A-2	300 GR. 5 NET	1 635	
122.1 123	PLATFORM STAIRS	684	636	A-2	5 NET	128 0	S E S S
	TOTALS 1ST FLOOR:	- 8,481	7,805	<u></u>	1	945	δ <sup>-</sup>
<u>SEC</u> RUM.	OND FLOOR	5.F.	5.F.			OCCUPANCY	
NR.	ROOM NAME STORAGE	(GR.) 36	(NET)	0CC. 5-1	RATIO 300 GR.	LOAD 1	
202 203	VIP AREA 1 STORAGE	INCL.	INCL. 82	- 5-1	- 300 GR.	0	Revisions
204	VESTIBULE	INCL.	INCL.	-	-	0	
	RESTROOM RESTROOM	79 70	61 61	-	-	0	
	VIP AREA 2 LANDING	2,654 INCL.	2,446 INCL.	A-2 -	15 NET -	164 0	
-	TOTALS 2ND FLOOR: TOTAL - OCCUPANCY LC TOTAL - GROSS AREA - TOTAL - NET AREA - 1ST FRONT BAR FIRST FLOC 126 X 0.2 = 25.2	1ST & 2ND & 2ND FL	9 FLOORS: 00RS: <u>10,</u> -	<u>11,420</u> 479	<u> </u>	166	a    a    a    a    b    a    b    b    b    b    b    c
	25.2 X 0.5 = 12.6 (PROVIDED MAIN EXIT FC VENUE FIRST FLOOR / 51 (1 + 11 + 11 + 11 + 11 + 4 + 4 985 X 0.2 = 197	ECOND FL	<u>.00R EXITI</u>	NG CALCI			Drawing Number
	405 X 0.2 = 197 197 X 0.5 = 98.5 (PROVIDED MAIN EXIT FC	OR MAIN V	'ENUE IS 13	6")	PE	R 2022 CBC	

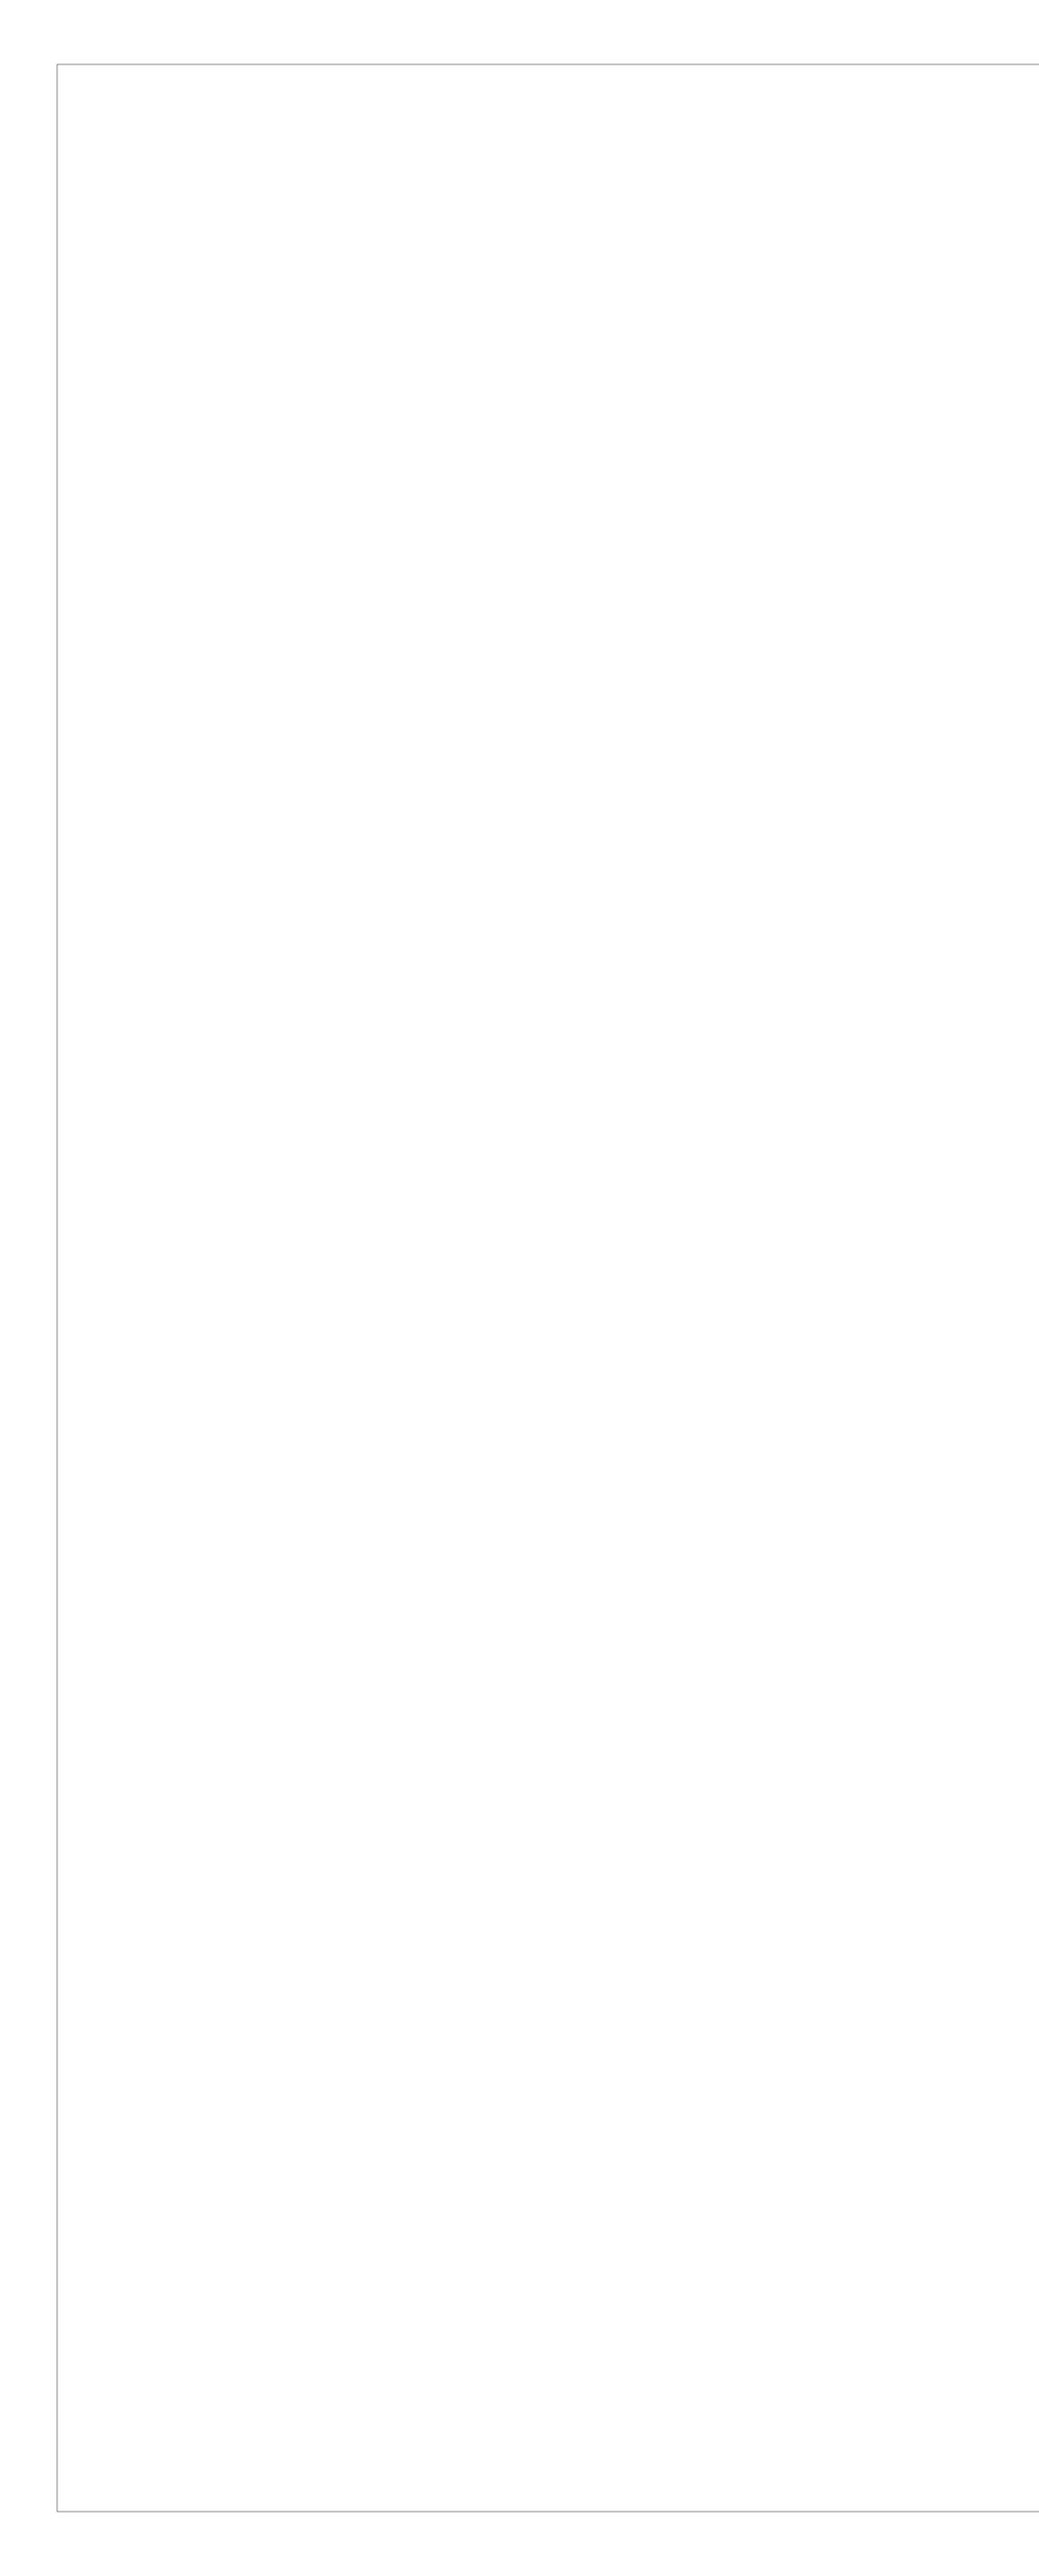

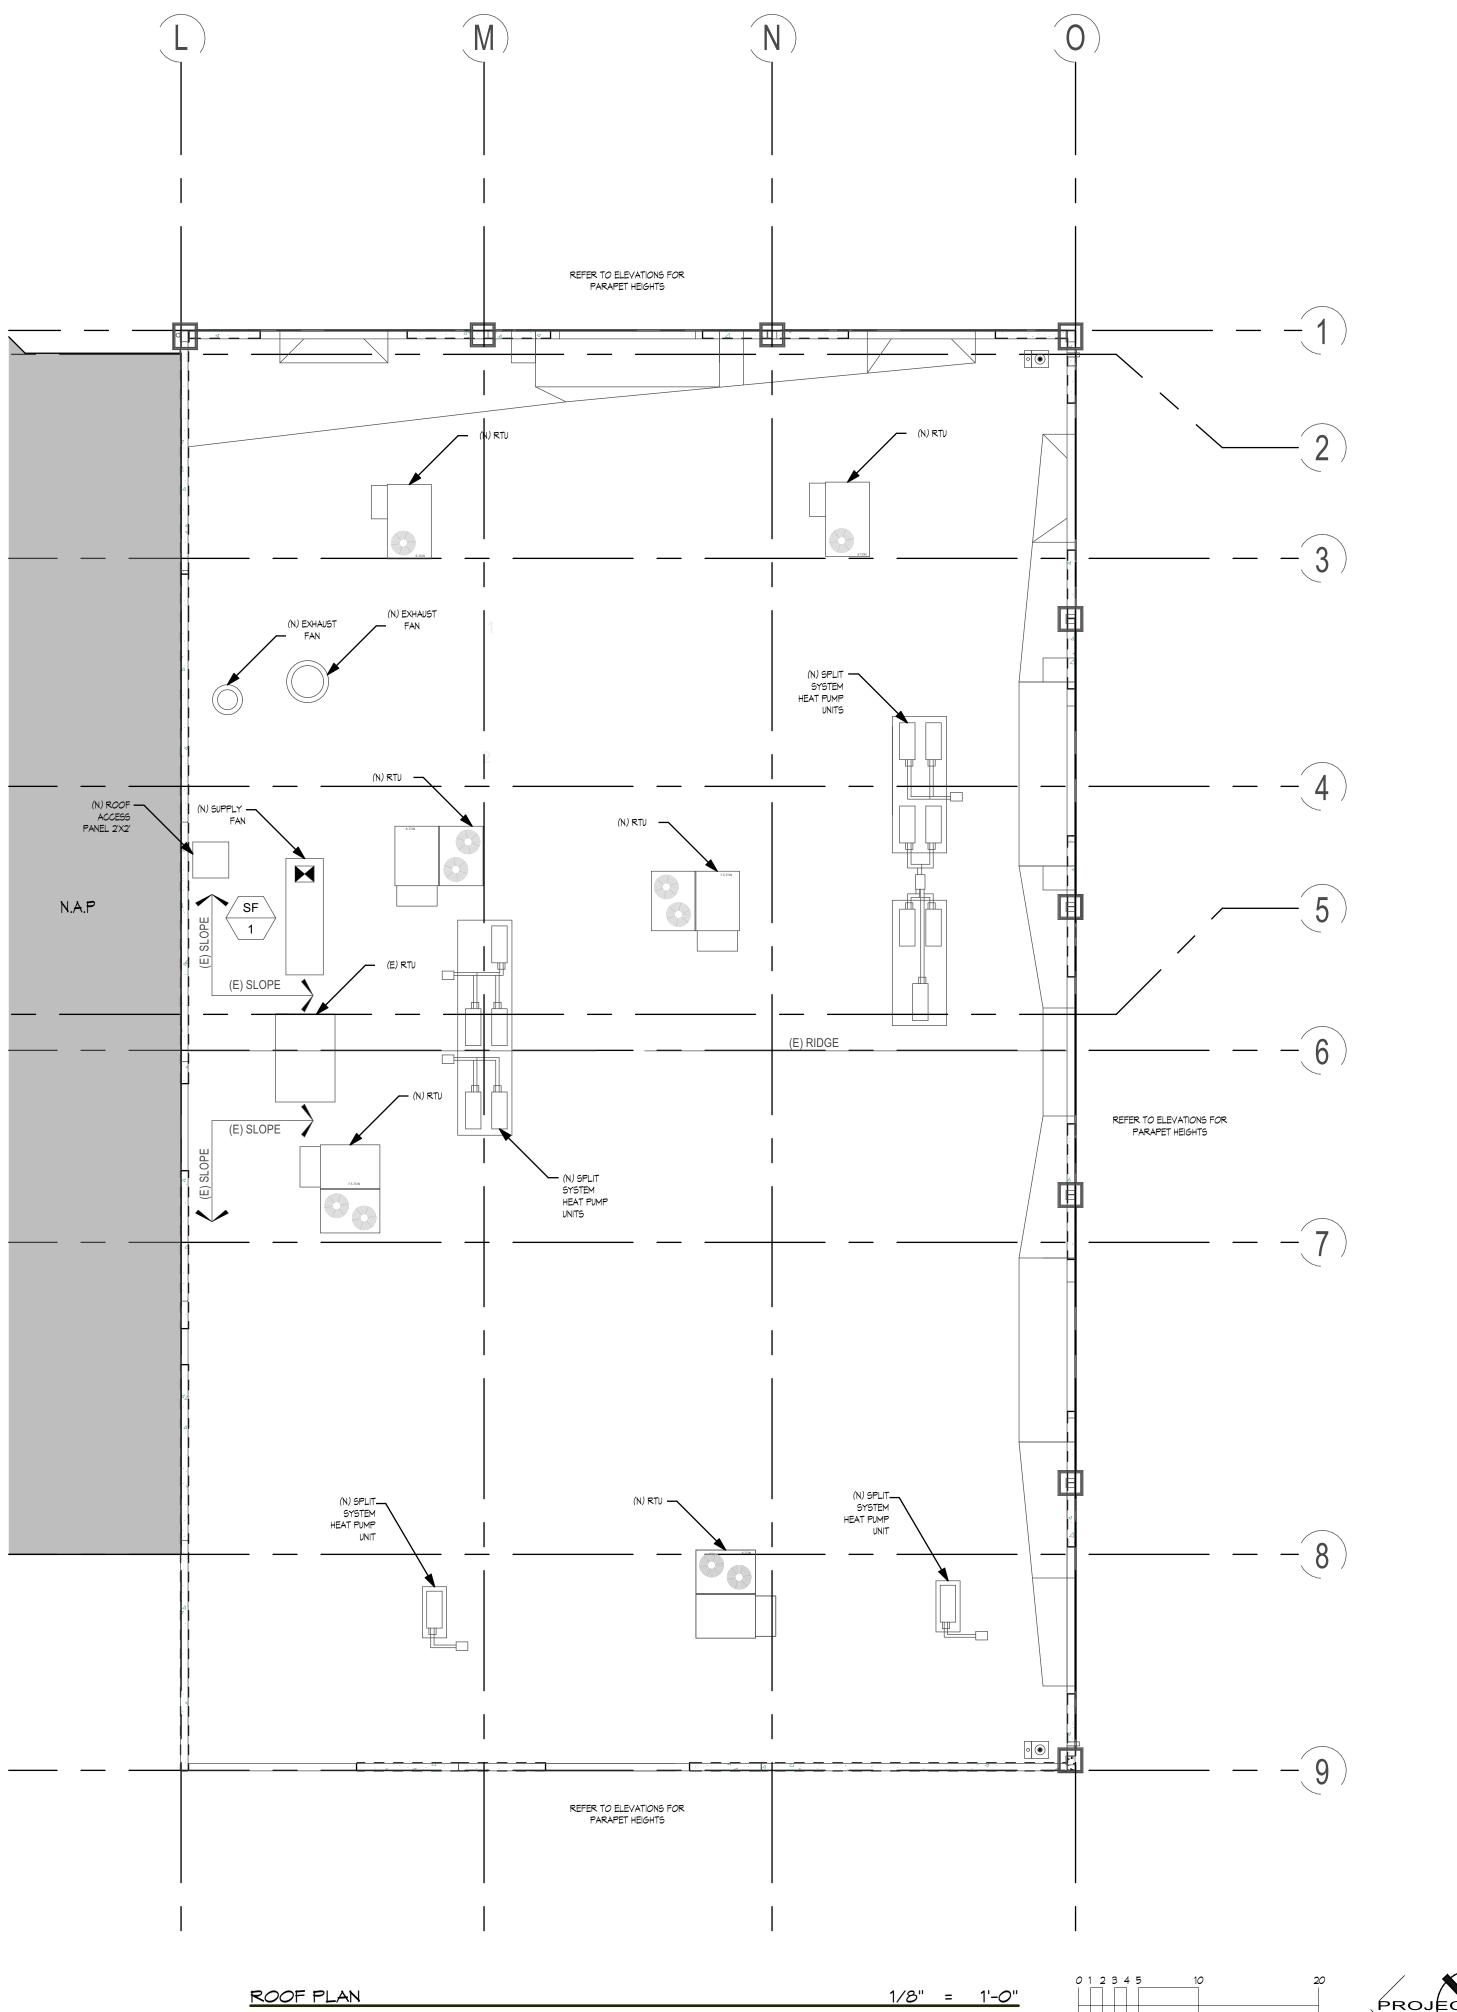



SCALE IN FEET

